

ajc architects

703 east 1700 south salt lake city, utah 84105 ph: 801,466,8818 fx: 801.466.4411 ajc@ajcarchitects.com

DOCUMENTS

D

UTAH STATE PRISON FEBRUARY, 2006 CONSTRUCTION CONSTRUCTION CONSTRUCTION

DRAPER, UTAH

DFCM PROJECT NO. 05032100

**OWNER** 

UTAH STATE DIVISION OF FACILITIES CONSTRUCTION AND MANAGEMENT

State Office Building Room 4110 Salt Lake City, Utah 84114 PH#: (801) 537-9116 FAX: (801) 538-3267 CONTACT: Vic Middleton; Project Manager

PLUMBING

MECHANICAL TO BE DESIGN BUILD

ELECTRICAL Thomas and Kolkman Engineering assoc.

46 West 1700 South Salt Lake City, Utah 84115 PH#: (801) 484-8161 FAX: (801) 484-3538 CONTACT: RAY KOLKMAN

**DRAWING INDEX:** 

GENERAL NOTES, SYMBOLS AND LEGENDS AND ABBREVIATIONS

UINTA, OQUIRRH, & VISITATION ROOM DEMOLITION AND NEW CONSTRUCTION FLOOR PLANS

OQUIRRH CONTROL & VISITATION ROOMS INTERIOR & WINDOW ELEVATIONS AE402 5

MILLWORK SECTIONS, ELEVATIONS AND DETAILS

WINDOW DETAILS UINTA EQUIPMENT PLANS, DEMOLITION PLAN

OQUIRRH EQUIPMENT PLAN, DEMOLITION PLAN UINTA GATE CONTROL PANEL DETAIL, WIRING DIAGRAM

AE502 7

EP601 10

OWNER INFORMATION

State of Utah Department of Administrative Services

ARCHITECTAJC PROJECT # 0568

ajc architects

703 east 1700 south

ph: 801.466.8818 fx: 801.466.4411

salt lake city, utah 84105

ajc@ajcarchitects.com



Salt Lake City, Utah 84114 Phone: (801) 538 - 3018 Fax: (801) 538 - 3267

Internet: http://www.dfcm.utah.gov

PROJECT DESCRIPTION

UTAH STATE PRISON CONTROL ROOM REMODEL

DRAPER, UTAH

SHEET NAME:

B COVER SHEET

REVISIONS

DATE DESCRIPTION

ISSUE DATA

ISSUE DATE: ISSUE TYPE: DRAWN BY:

CONDOC KRR CHECKED BY:

FEBRUARY 2006

CAD FILE NAME: 0568AAE101 DFCM PROJECT # 05032100 COPYRIGHT: STATE OF UTAH

SHEET NUMBER:

UTAH STATE PENITENTIARY; VICINITY MAP BUILDING LOCATION Bacchus Ponderosa Hill West Jordan (111) Sandy Canyo Riverton Draper ham Canyon

SCOPE OF WORK

Wood Hollow Ranchettes

**UINTA CONTROL ROOM:** 

ALL WORK REQUIRED TO REMOVE THE EXISTING BARS AROUND THE CONTROL ROOM, REMOVE THE EXISTING GLAZING AND REPLACE WITH TINTED LEXGARD.

ALL WORK REQUIRED TO DEMOLISH AND REMOVE EXISTING MILLWORK AND HAND SINK AND INSTALL NEW MILLWORK AS INDICATED HEREIN.

ALL WORK REQUIRED TO REMOVE EXISTING WATER CLOSET, RE-PLUMB AND INSTALL NEW STAINLESS STEEL WATER CLOSET/LAV. ASSEMBLY WITH NEW ON DEMAND WATER HEATER AS INDICATED HEREIN.

ALL WORK REQUIRED TO PROVIDE AND INSTALL (2) NEW CALL BUTTONS.

OQUIRRH CONTROL ROOMS (4 TOTAL):

ALL WORK REQUIRED TO REMOVE EXISTING GLAZING AND INSTALL NEW TINTED

ALL WORK REQUIRED TO DEMOLISH AND REMOVE EXISTING MILLWORK AND INSTALL NEW MILLWORK AS INDICATED HEREIN.

NON CONTACT VISITATION ROOMS (53 TOTAL):


(OQUIRRH:23, UINTA 1:8, UINTA 3:9, UINTA 4:10, OLYMPUS:3)


ALL WORK REQUIRED TO REMOVE EXISTING GLAZING AND COMMUNICATIONS PORT AND INSTALL NEW LEXGARD VIEW / COMMUNICATION WINDOW AS INDICATED HEREIN


LEGAL VISITATION ROOM (1 TOTAL):


(OQUIRRH: 1)


ALL WORK REQUIRED TO REMOVE EXISTING BARS AND INSTALL NEW LEXGARD VIEW / COMMUNICATION / TRANSACTION WINDOW AS INDICATED HEREIN.

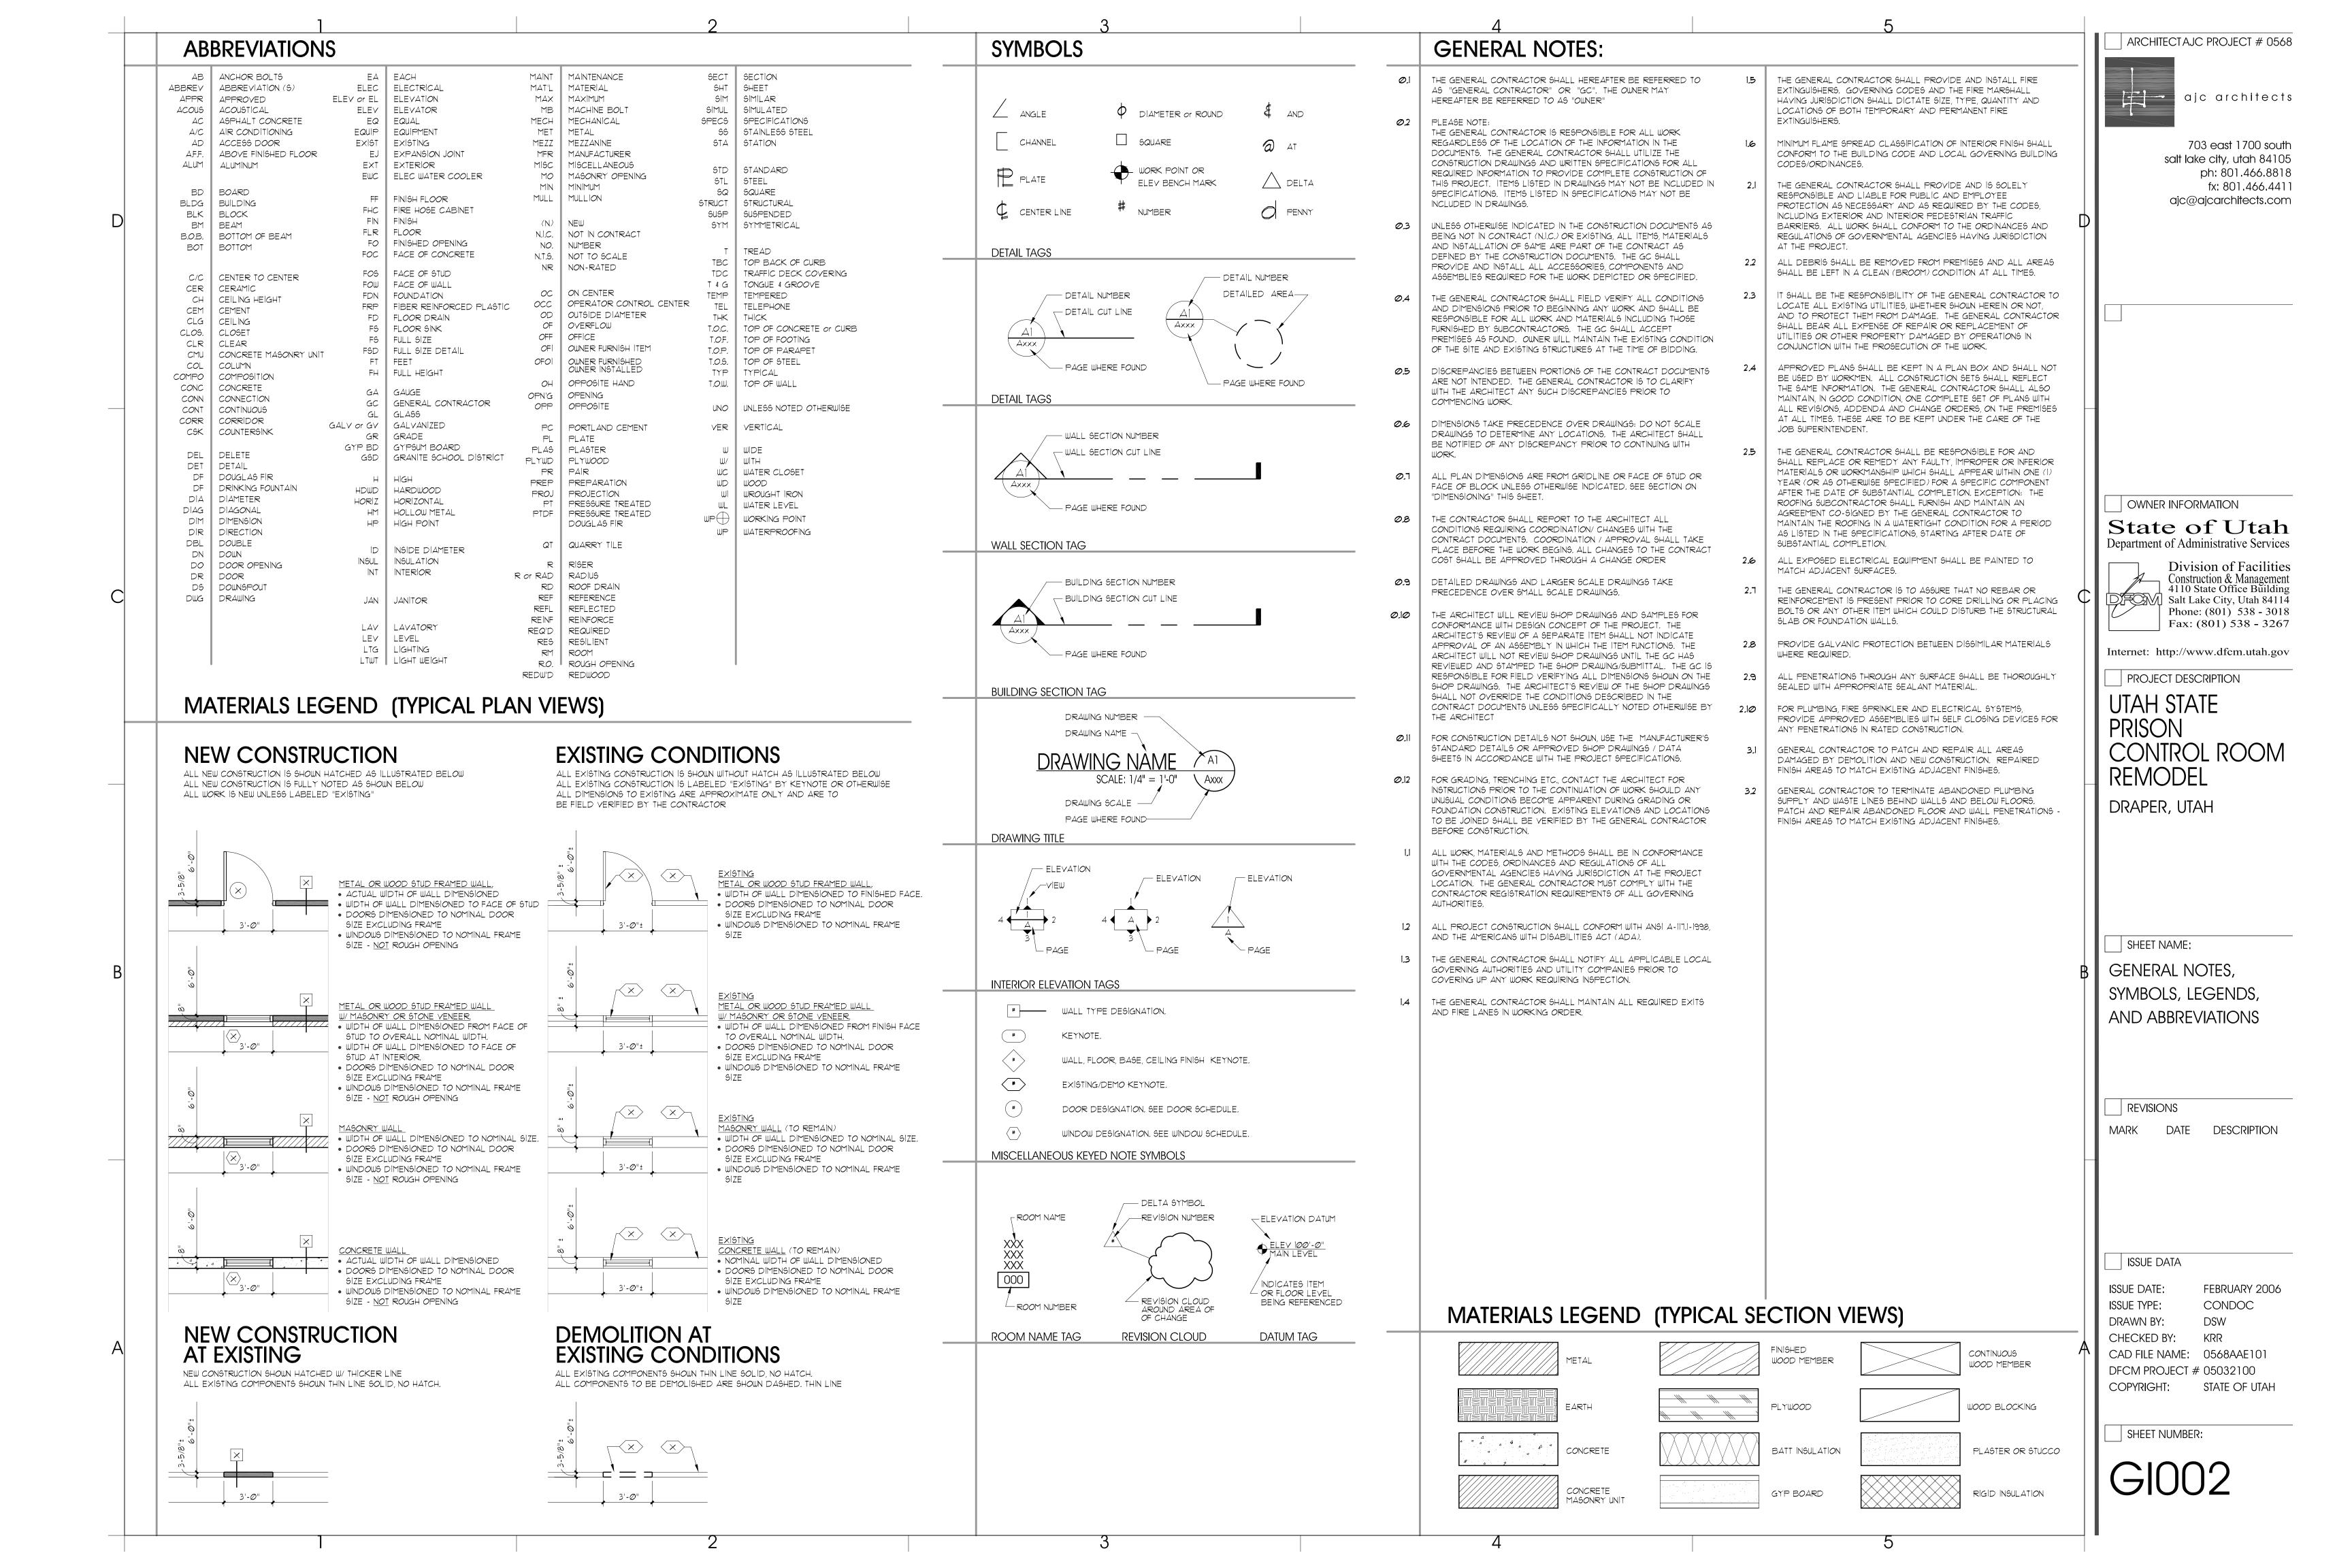


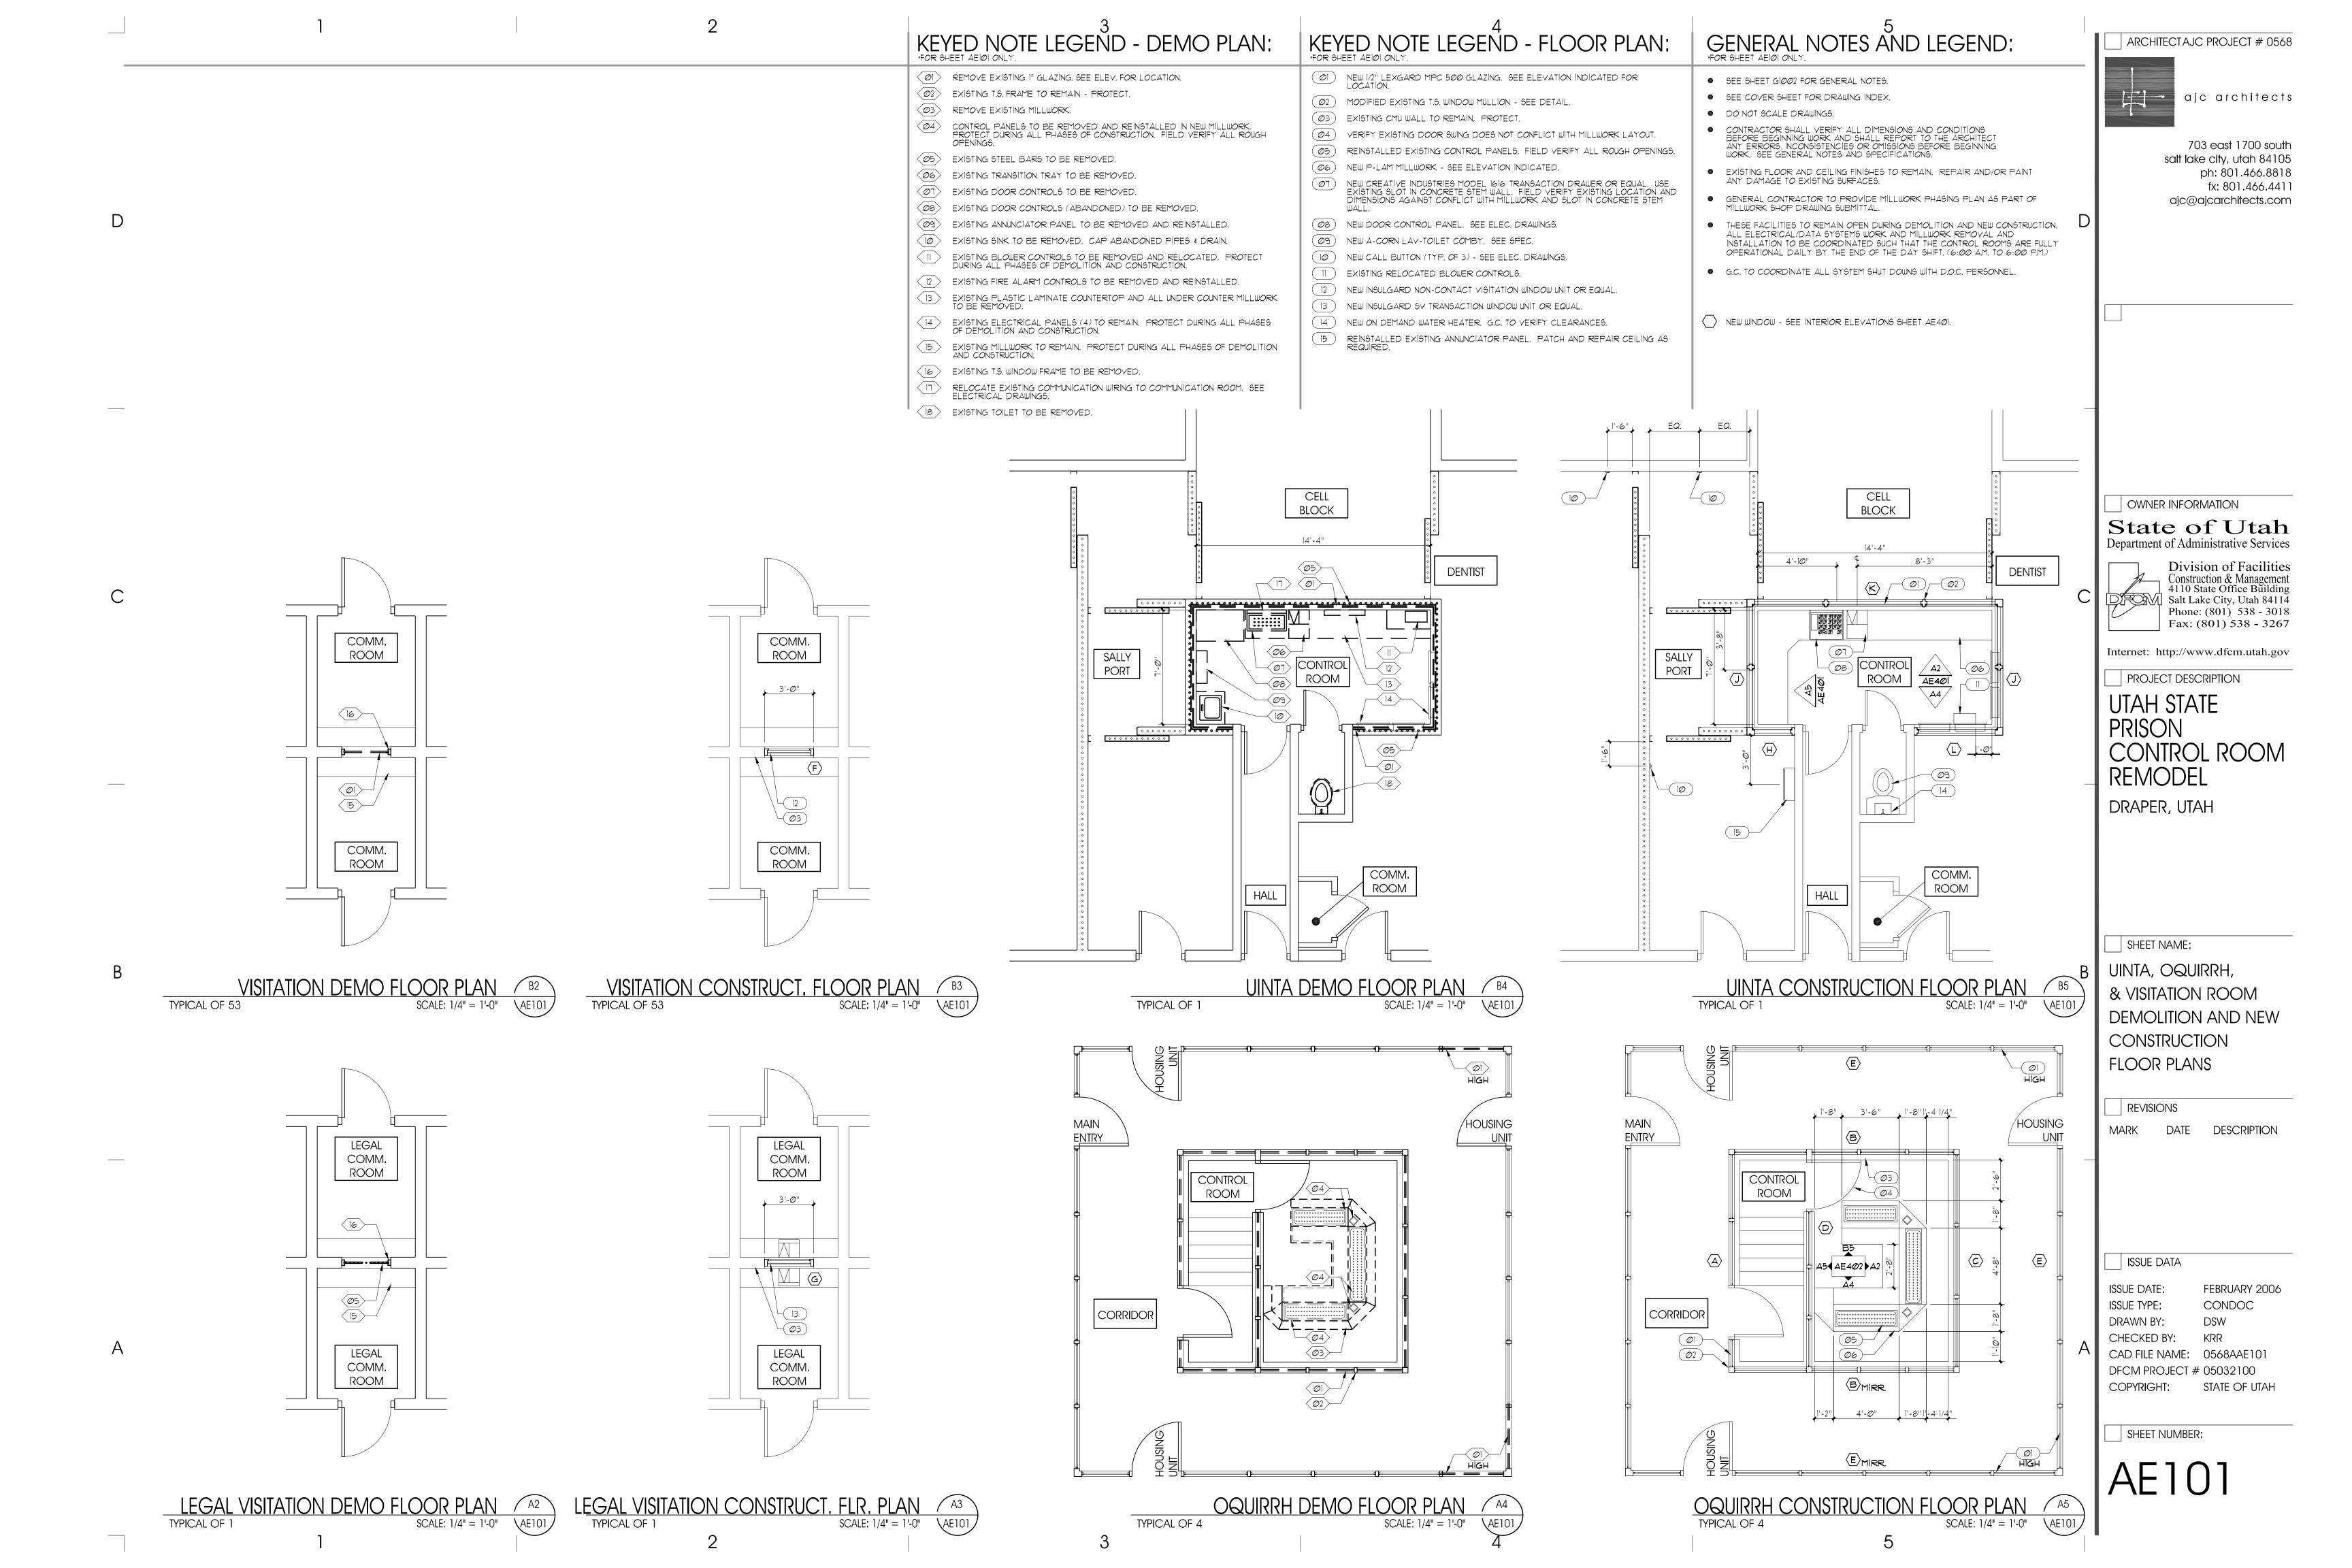

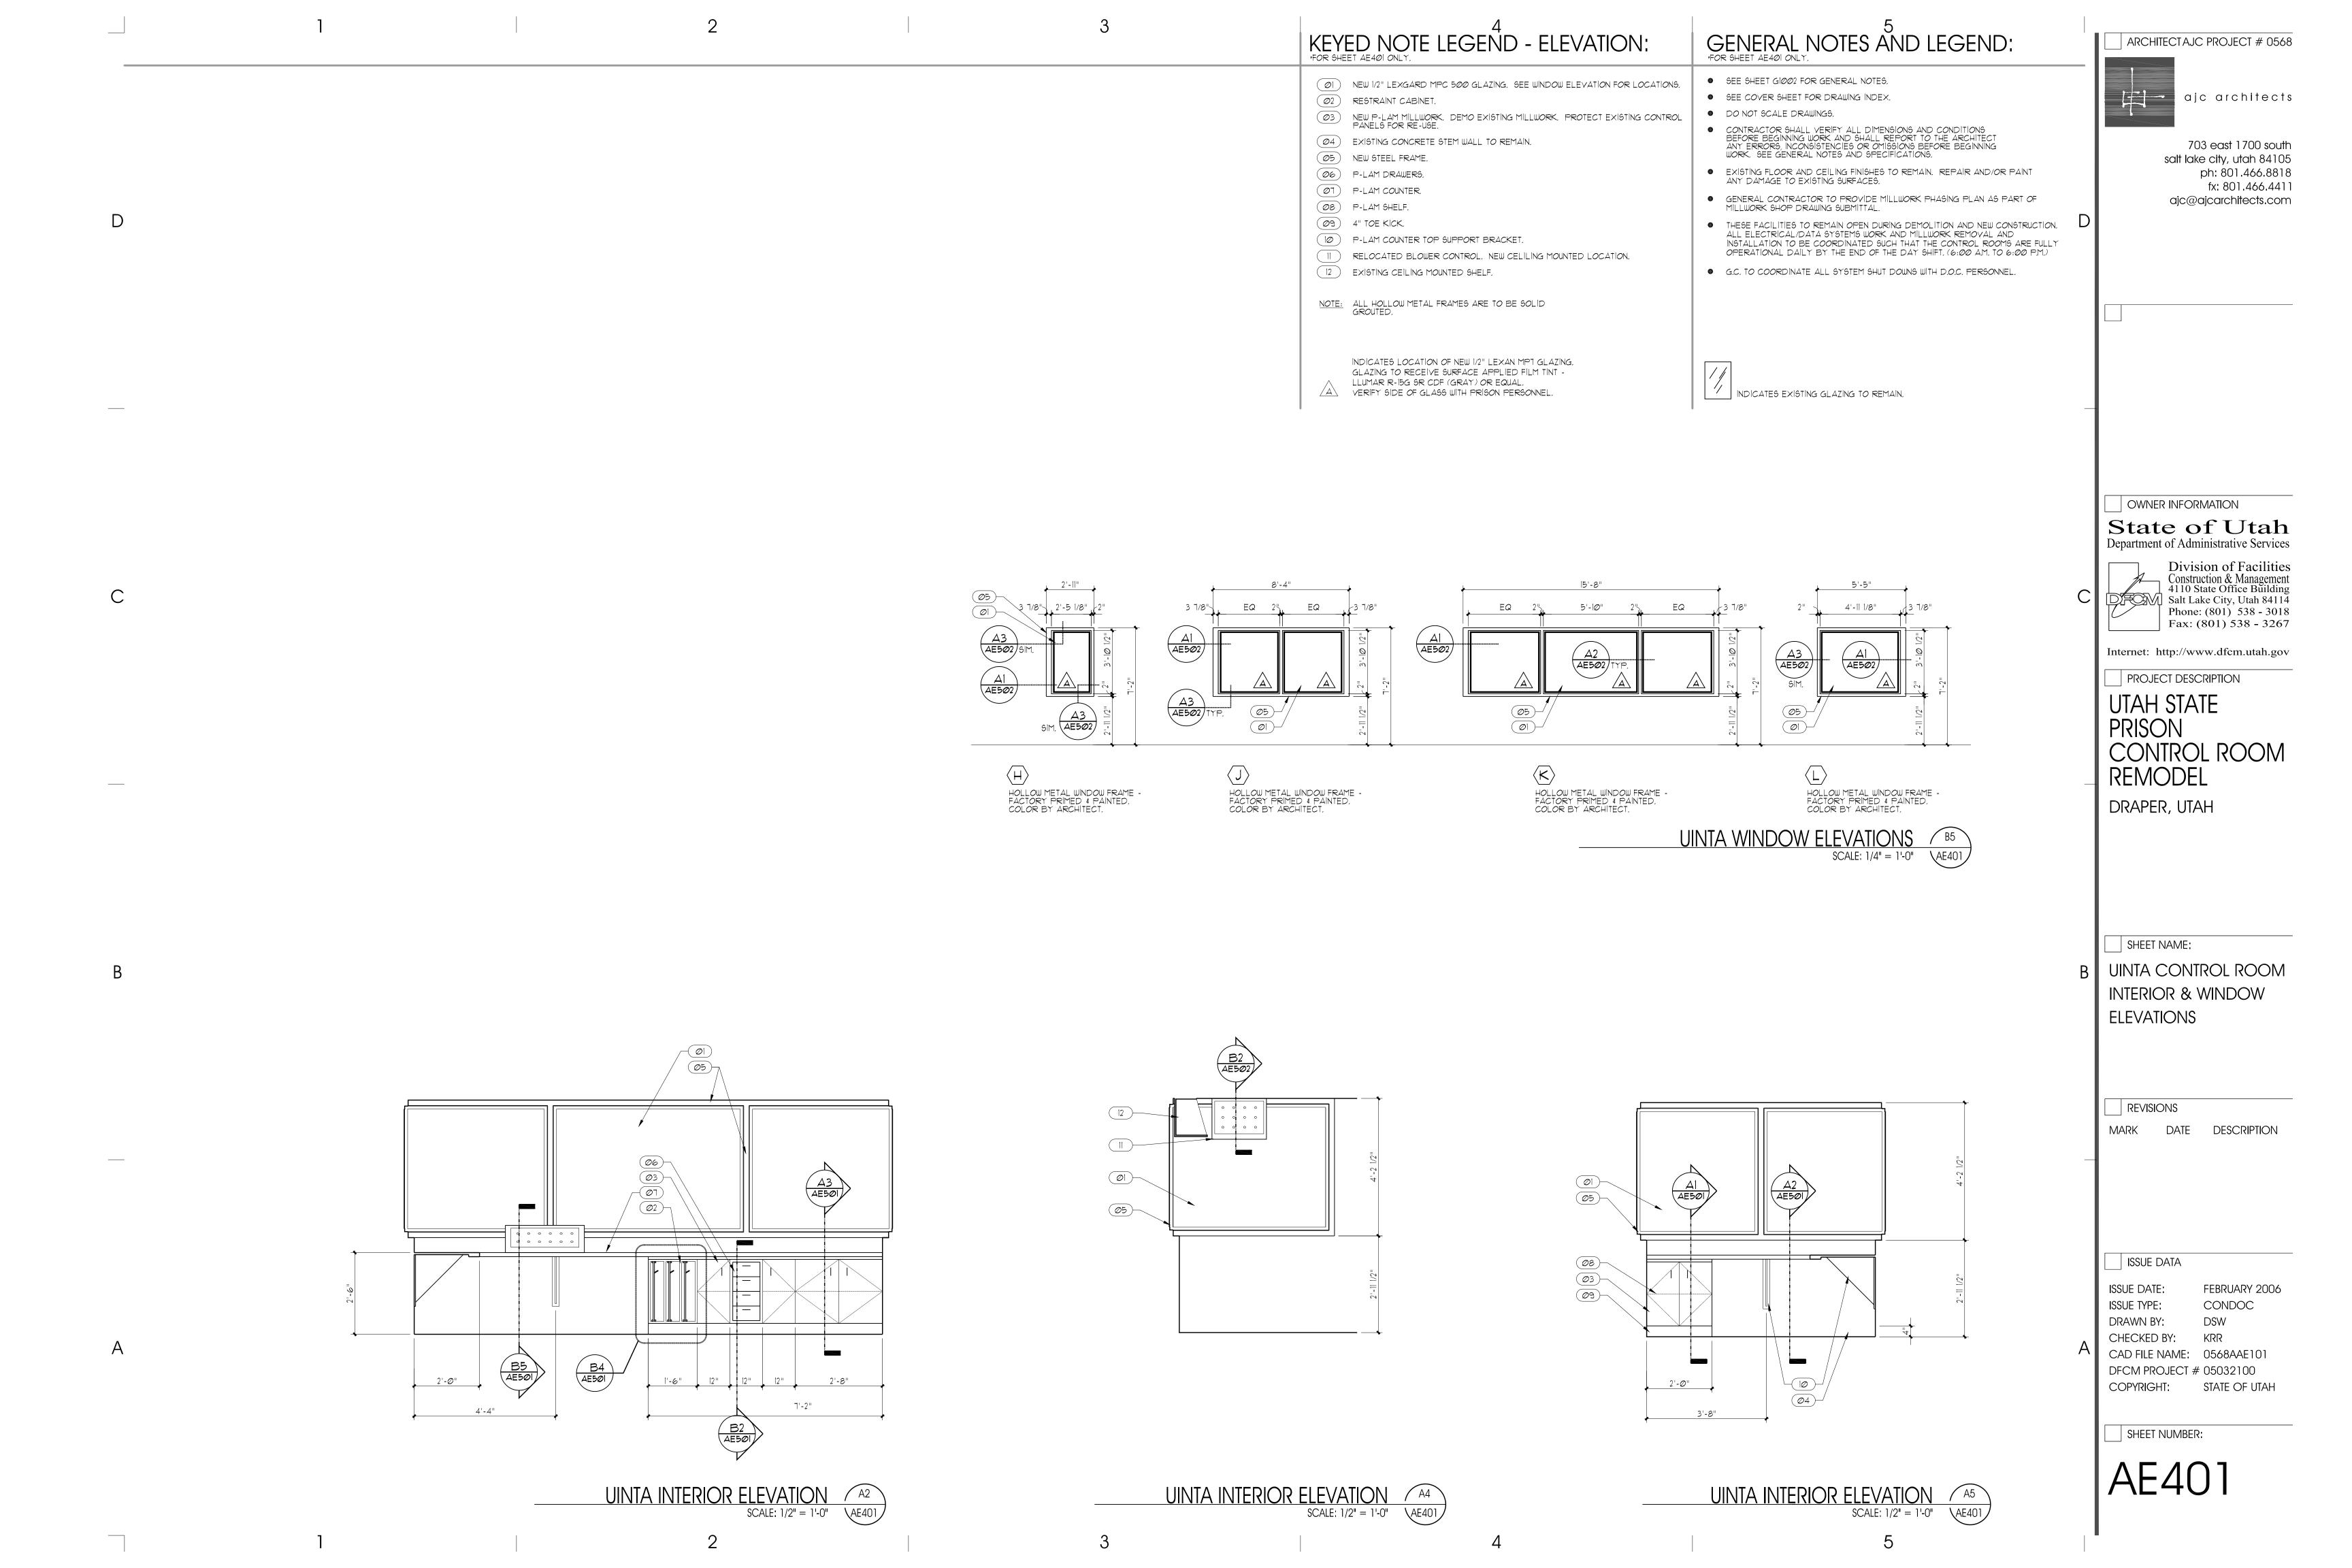


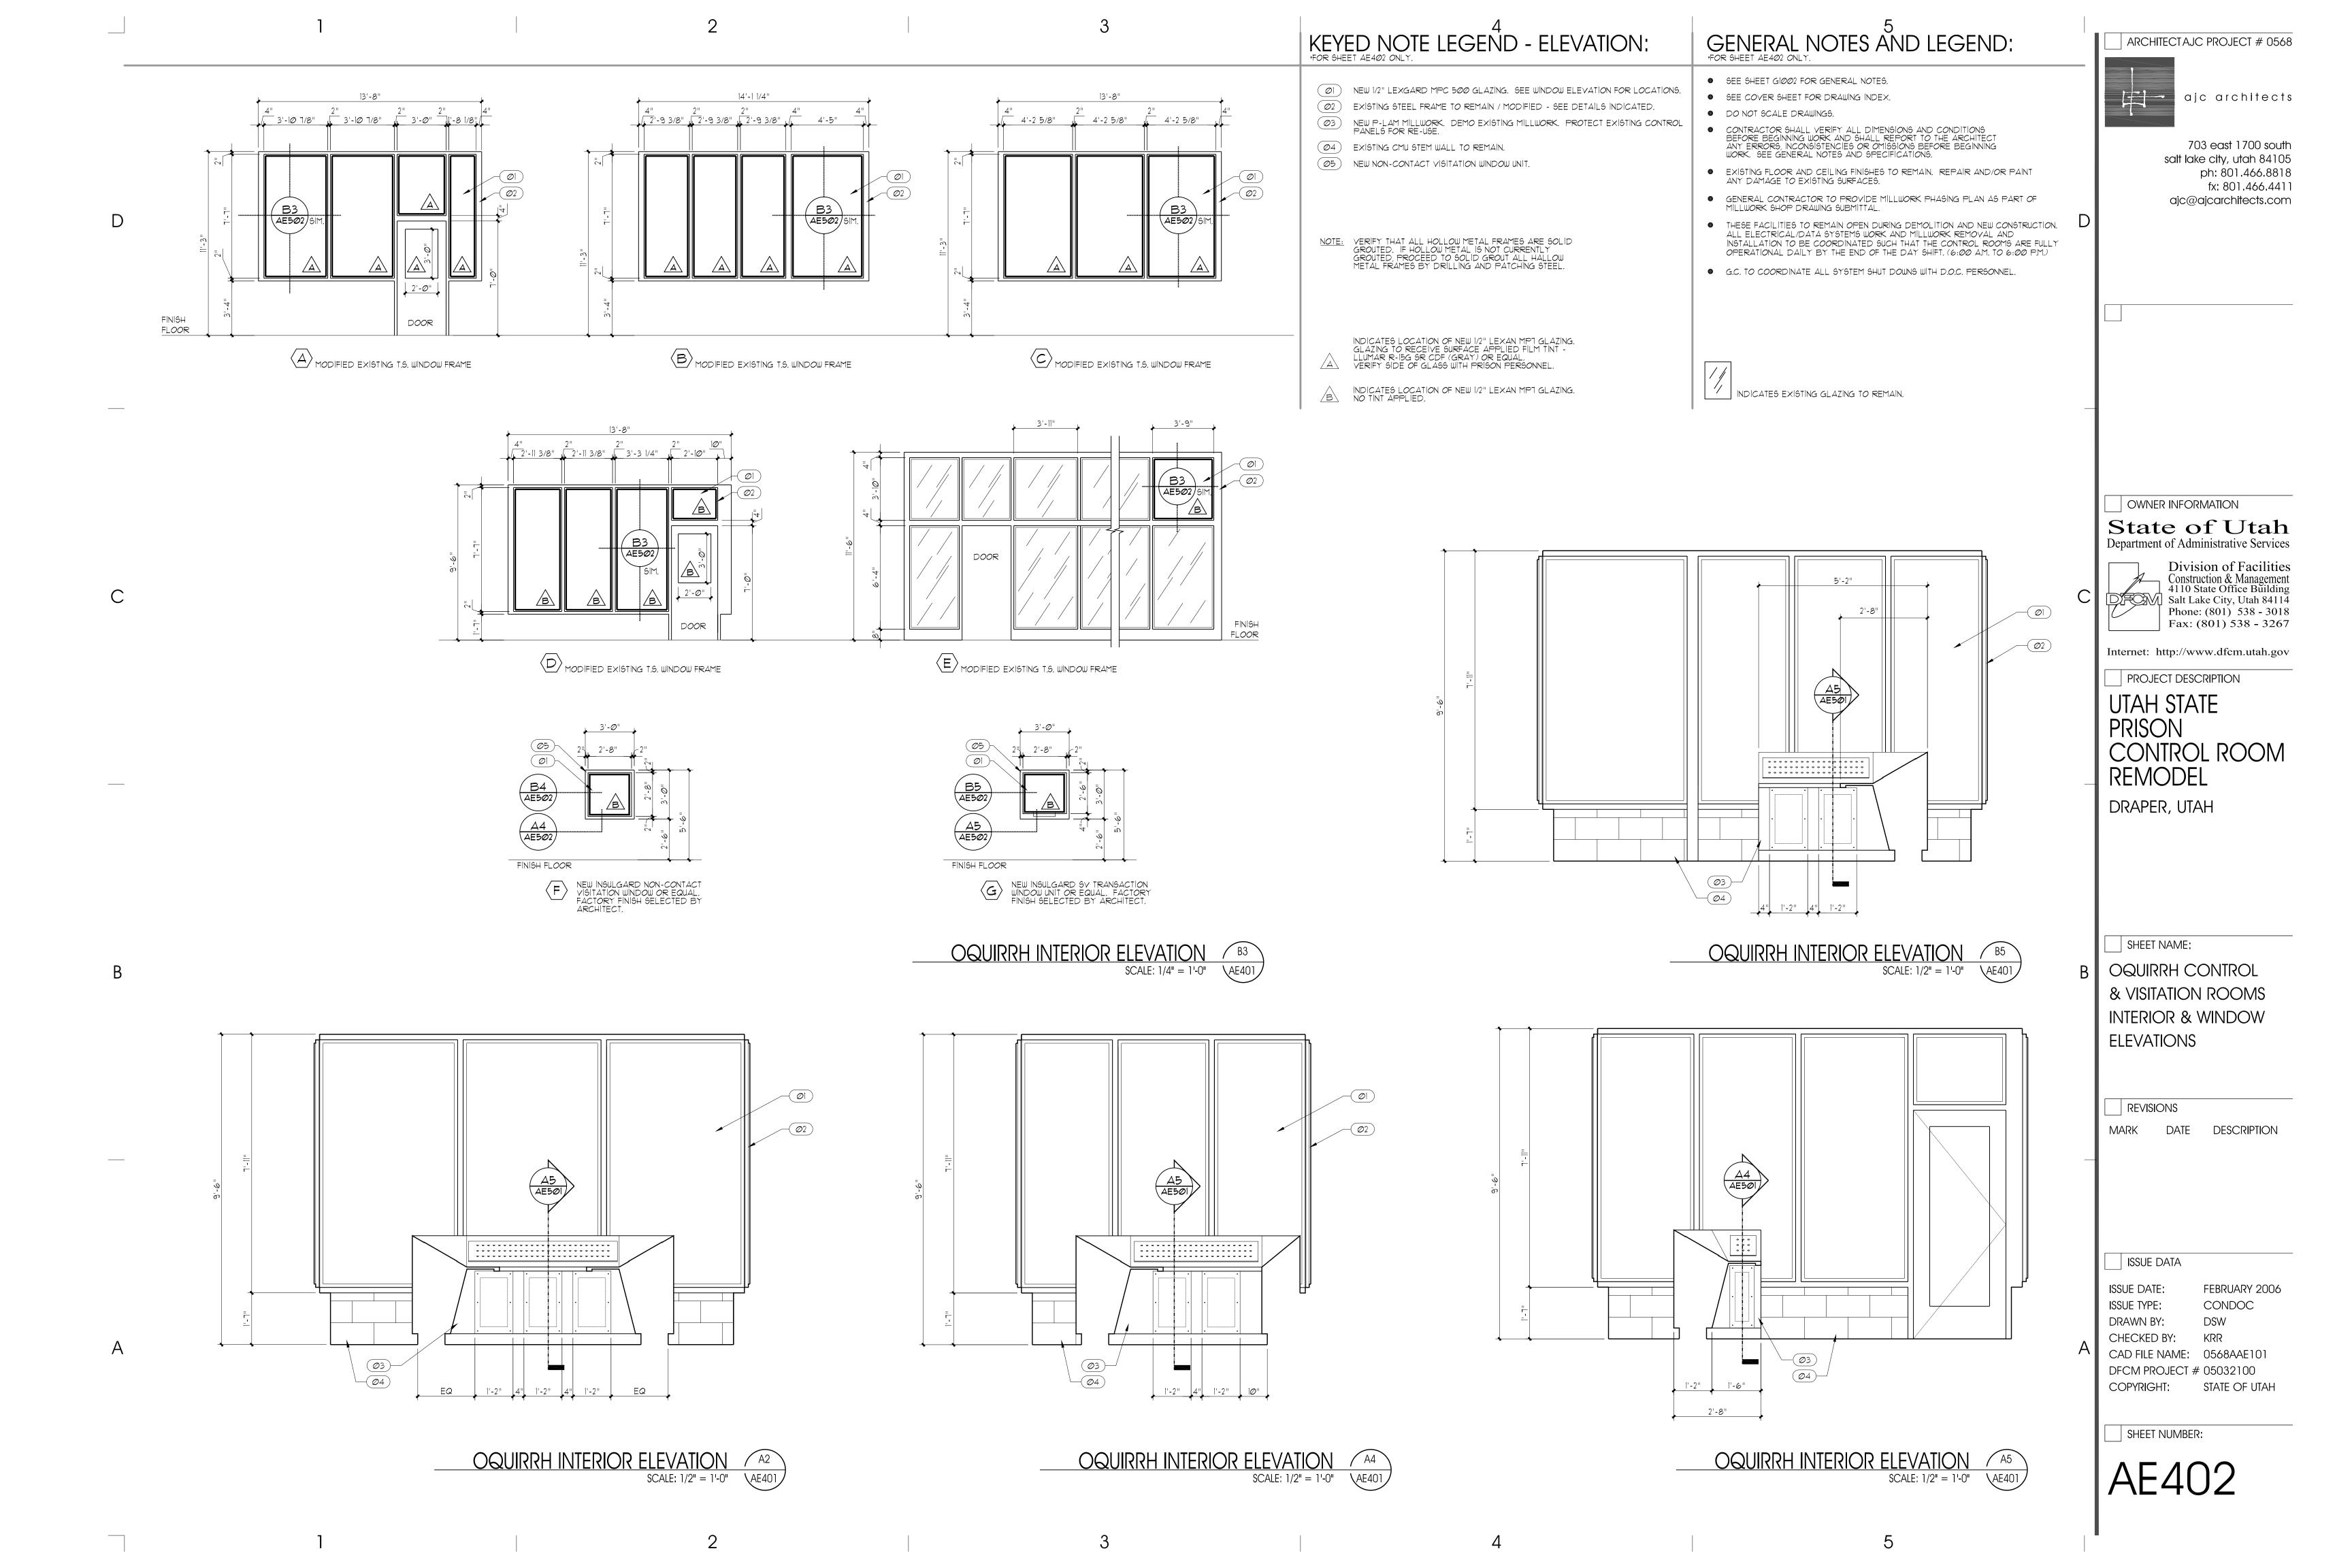

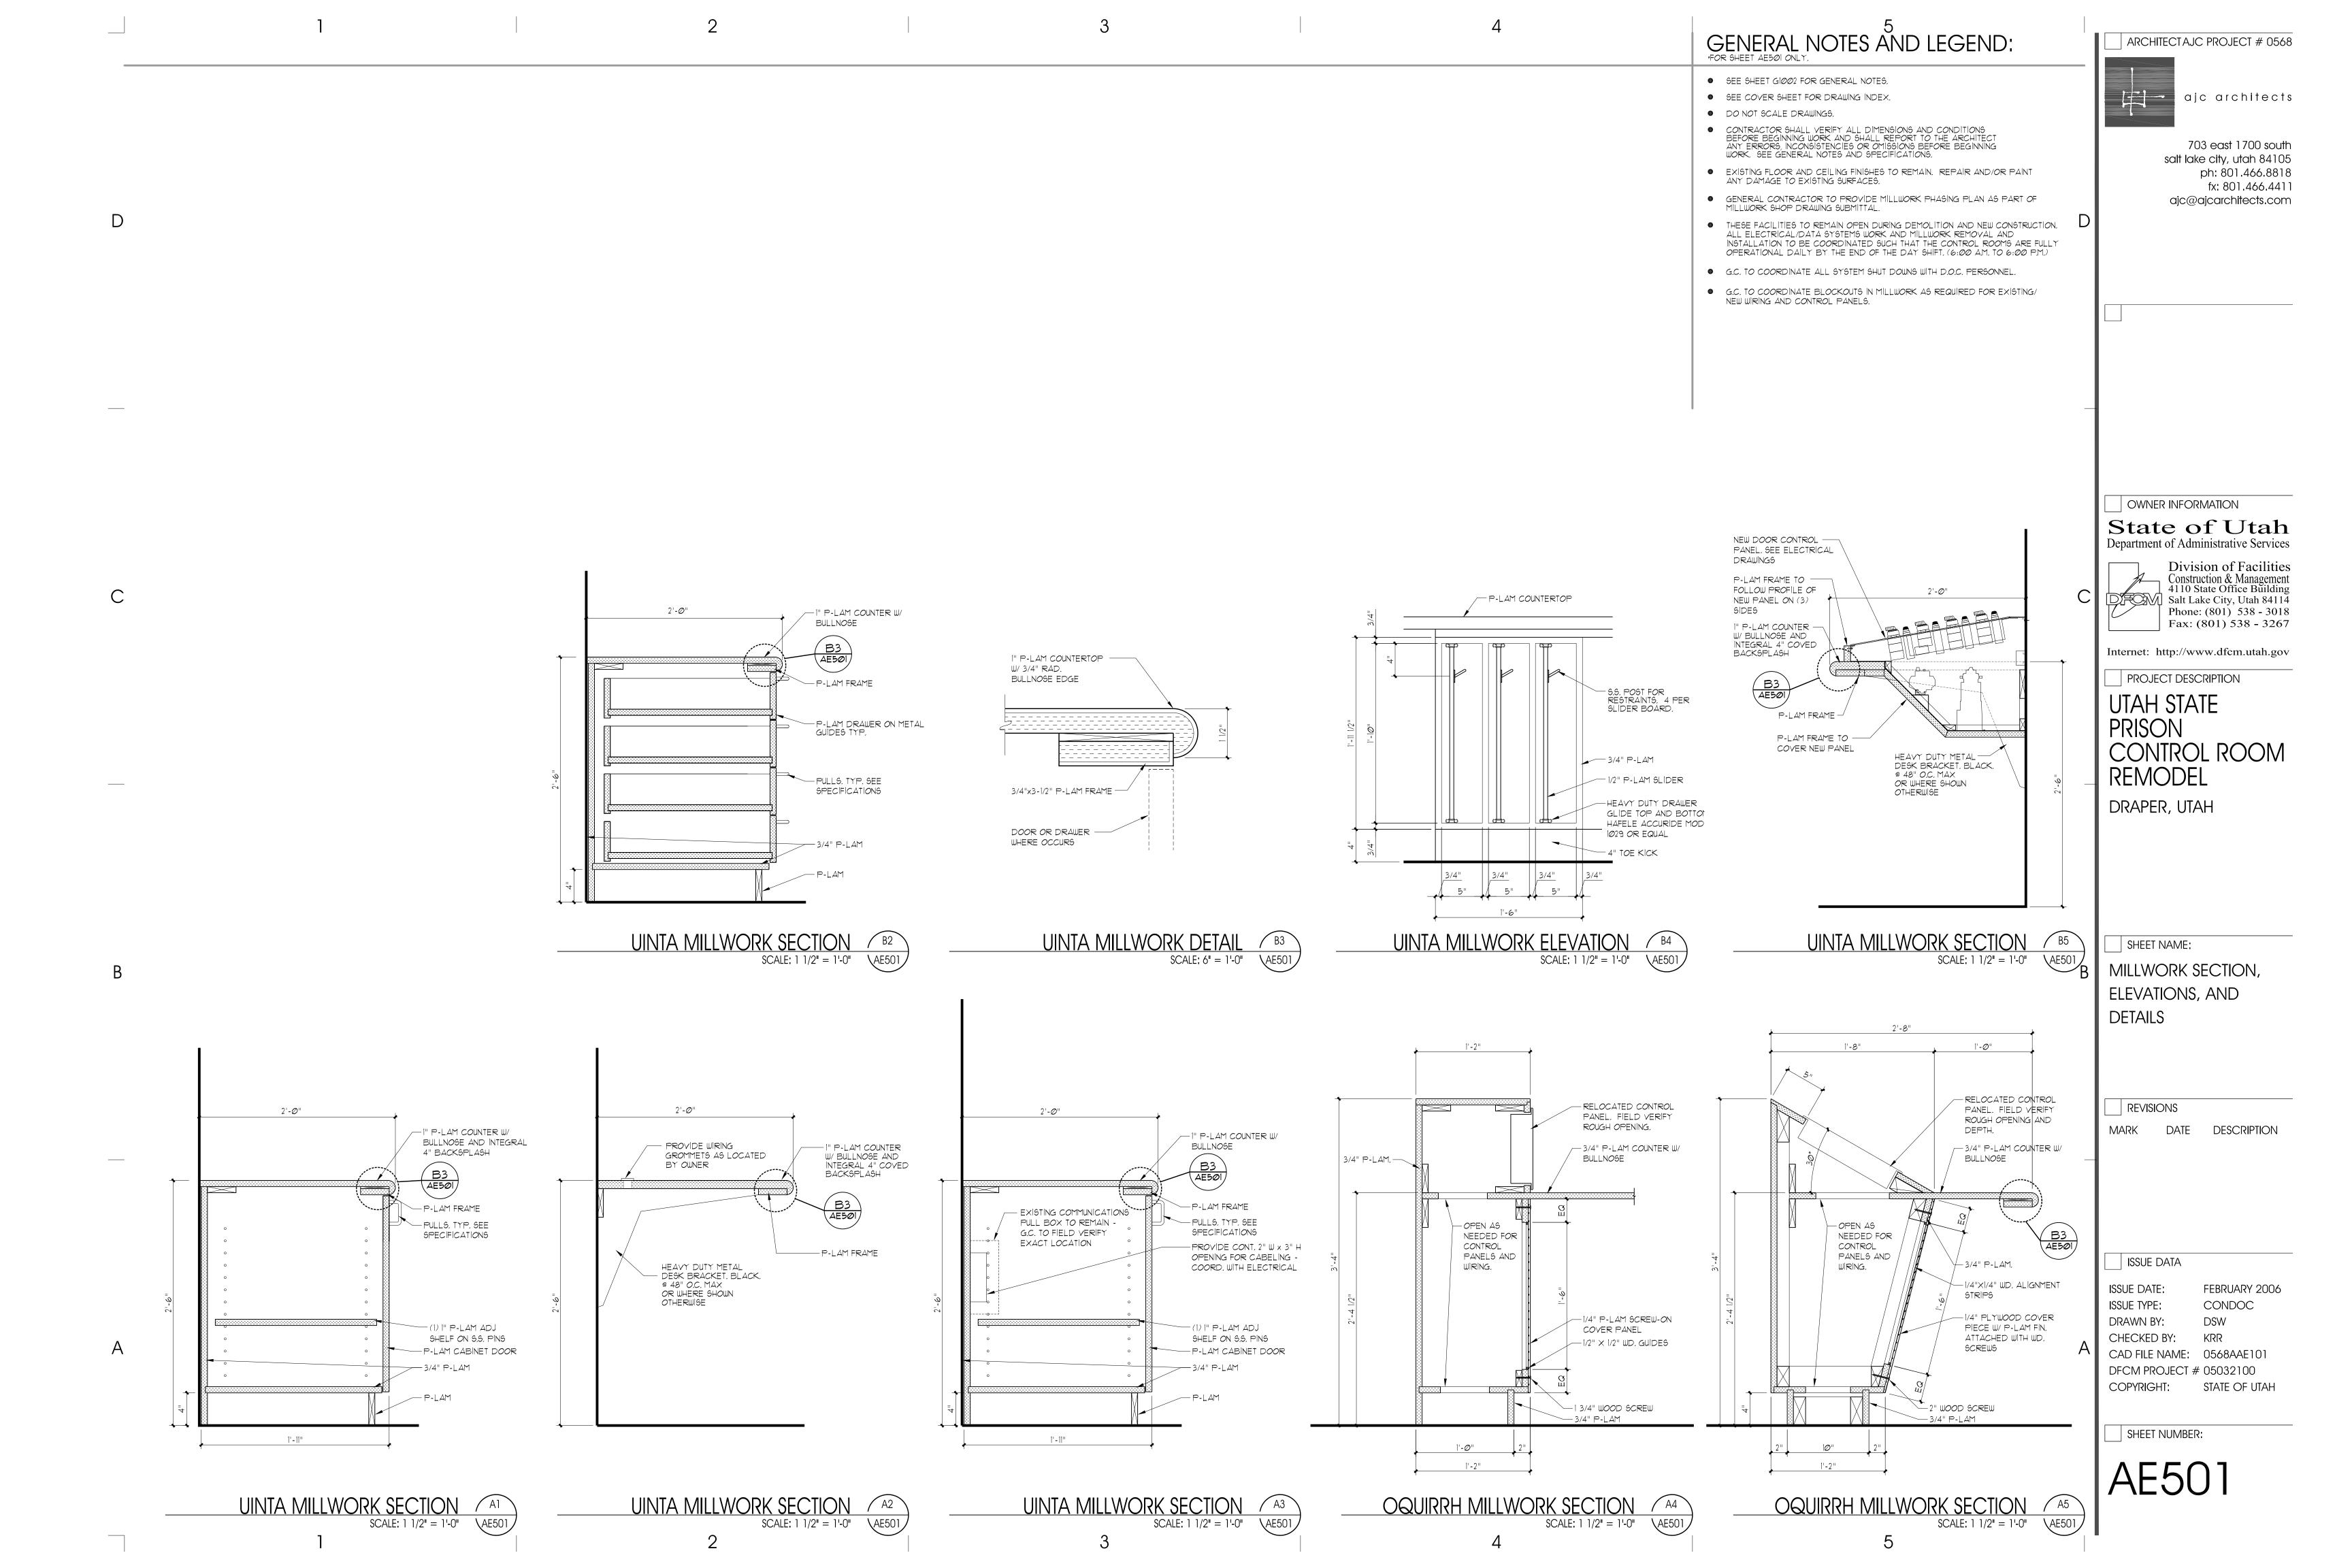

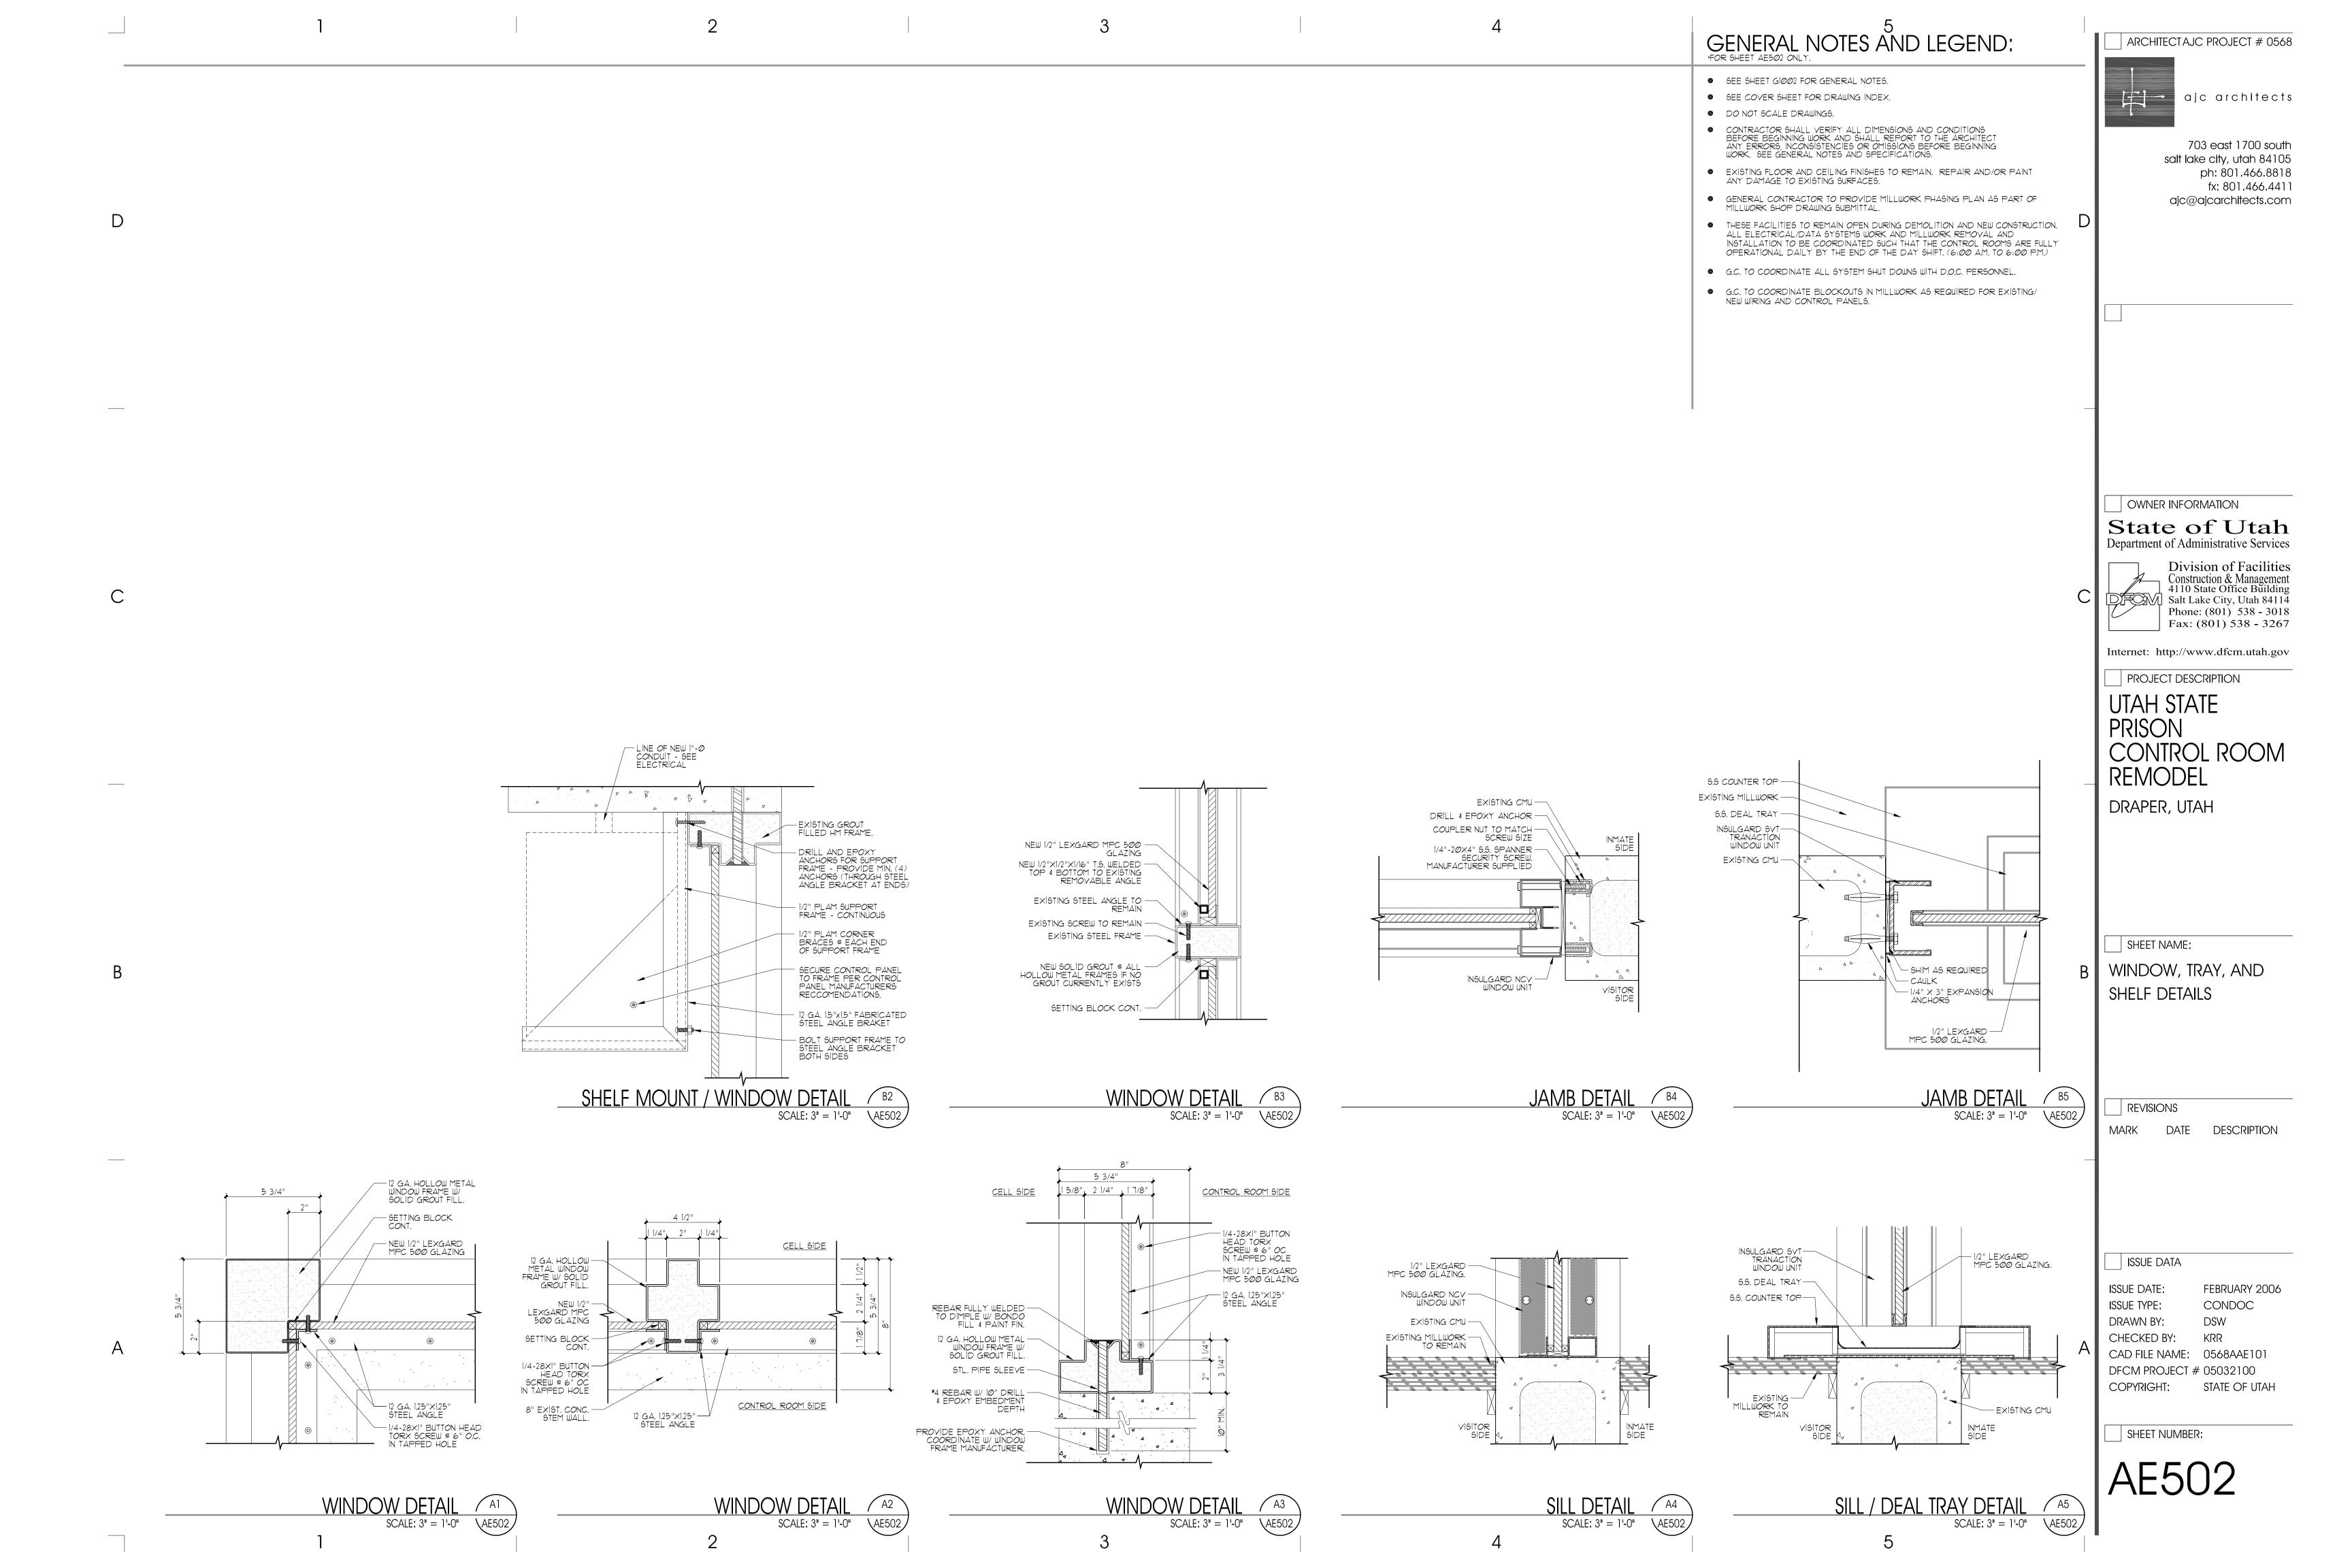



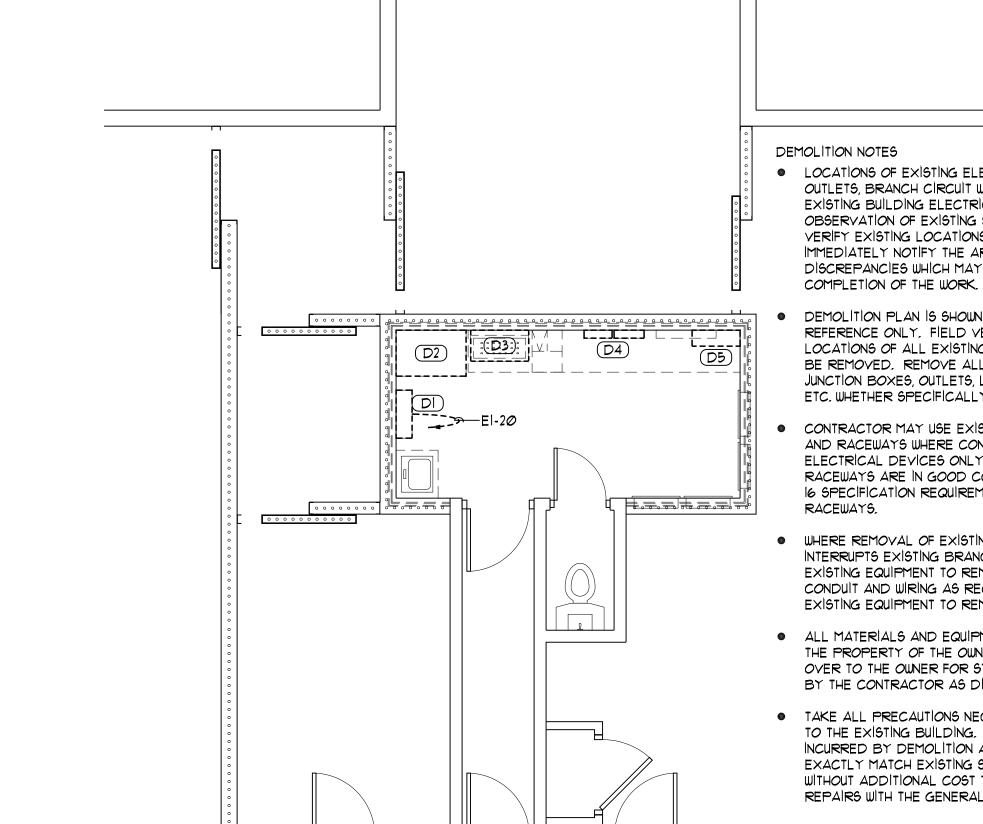

DEMOLITION NOTES LOCATIONS OF EXISTING ELECTRICAL EQUIPMENT, SWITCHES, OUTLETS, BRANCH CIRCUIT WIRING, ETC., ARE BASED ON EXISTING BUILDING ELECTRICAL DRAWINGS AND FIELD OBSERVATION OF EXISTING SURFACE CONDITIONS, FIELD VERIFY EXISTING LOCATIONS AND CIRCUITING AND IMMEDIATELY NOTIFY THE ARCHITECT OF ANY DISCREPANCIES WHICH MAY ADVERSELY AFFECT

DEMOLÍTION PLAN IS SHOWN FOR CONTRACTORS REFERENCE ONLY, FIELD VERIFY QUANTITIES AND LOCATIONS OF ALL EXISTING MATERIAL AND EQUIPMENT TO BE REMOVED. REMOVE ALL ABANDONED CONDUIT WIRING, JUNCTION BOXES, OUTLETS, LIGHT FIXTURES, EQUIPMENT, ETC. WHETHER SPECIFICALLY SHOWN OR NOT.


 CONTRACTOR MAY USE EXISTING BRANCH CIRCUIT WIRING AND RACEWAYS WHERE CONVENIENT TO CONNECT TO NEW ELECTRICAL DEVICES ONLY IF THE EXISTING WIRING AND RACEWAYS ARE IN GOOD CONDITION AND MEET DIVISION 16 SPECIFICATION REQUIREMENTS FOR NEW WIRING AND RACEWAYS.

• WHERE REMOVAL OF EXISTING ELECTRICAL EQUIPMENT INTERRUPTS EXISTING BRANCH CIRCUITS OR FEEDERS TO EXISTING EQUIPMENT TO REMAIN, FURNISH AND INSTALL NEW CONDUIT AND WIRING AS REQUIRED TO RECONNECT THE EXISTING EQUIPMENT TO REMAIN.

• ALL MATERIALS AND EQUIPMENT REMOVED SHALL REMAIN THE PROPERTY OF THE OWNER AND SHALL BE TURNED OVER TO THE OWNER FOR STORAGE OR BE DISPOSED OF BY THE CONTRACTOR AS DIRECTED BY THE OWNER.

• TAKE ALL PRECAUTIONS NECESSARY TO AVOID DAMAGE TO THE EXISTING BUILDING, REPAIR ALL DAMAGE INCURRED BY DEMOLITION AND NEW CONSTRUCTION TO EXACTLY MATCH EXISTING SURFACES AND/OR CONDITIONS WITHOUT ADDITIONAL COST TO THE OWNER. COORDINATE REPAIRS WITH THE GENERAL CONTRACTOR.

<u>UINTA CONTROL ROOM DEMOLITION PLAN</u> scale = 1/4" = 1'-0"

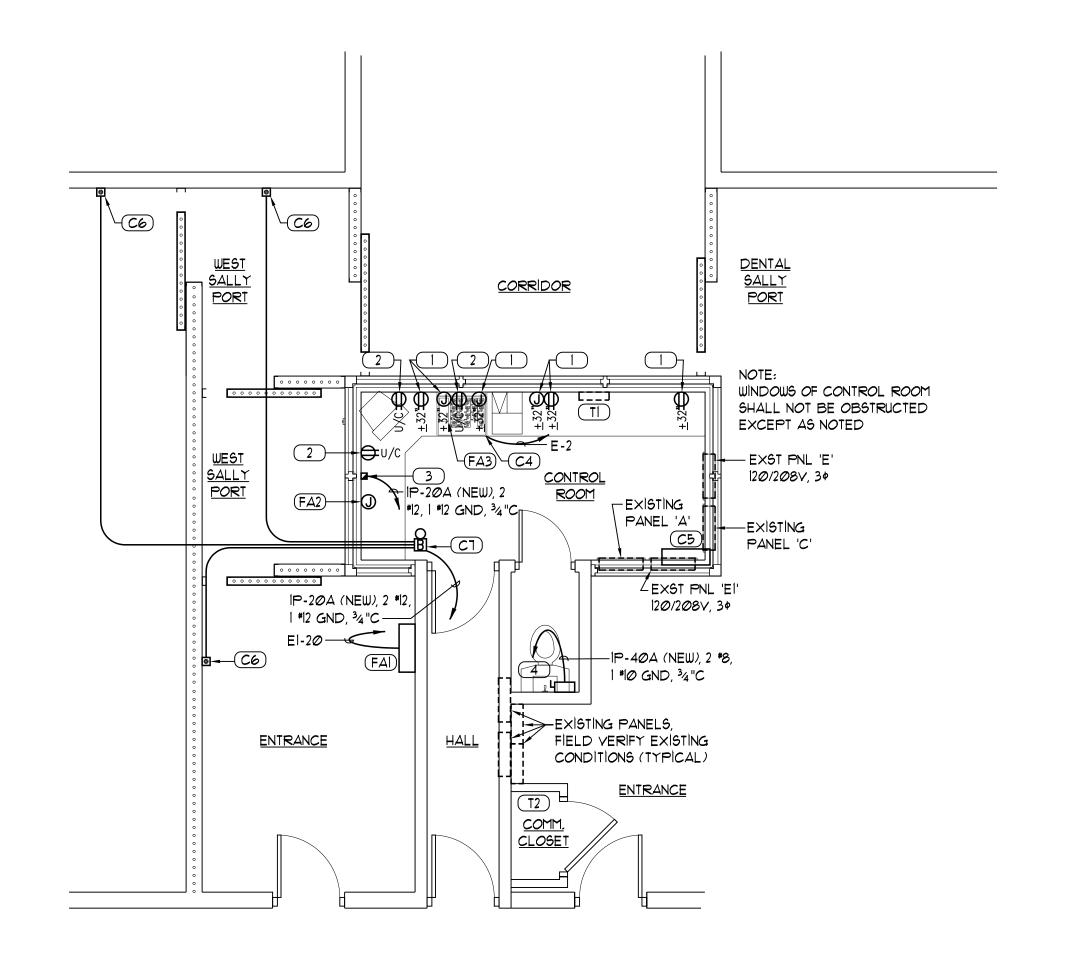

UINTA CONTROL ROOM EQUIPMENT PLAN scale = 1/4" = 1'-0"

**GENERAL NOTES** 

• WHERE BRANCH CIRCUIT HOMERUNS INDICATE WIRE SIZES, THE BRANCH CIRCUIT SHALL BE THAT SIZE WIRE THROUGHOUT, INCLUDING SWITCH LEGS, ETC.

• COORDINATE EXISTING CEILING, WALLS AND FLOOR REPAIRS WITH THE GENERAL CONTRACTOR.

• LOCATIONS OF EXISTING ELECTRICAL EQUIPMENT, SWITCHES, OUTLETS, BRANCH CIRCUIT WIRING, ETC., ARE BASED ON EXISTING BUILDING ELECTRICAL DRAWINGS AND FIELD OBSERVATION OF EXISTING SURFACE CONDITIONS, FIELD VERIFY EXISTING LOCATIONS AND CIRCUITING AND IMMEDIATELY NOTIFY THE ARCHITECT OF ANY DISCREPANCIES WHICH MAY ADVERSELY AFFECT COMPLETION OF THE WORK.

**KEYED NOTE LEGEND:** 

1 ) EXISTING OUTLET BOX FLUSH IN MASONRY, PROVIDE BOX EXTENSION AS REQUIRED TO FLUSH OUTLET WITH NEW BACK SPLASH, PROVIDE NEW DUPLEX RECEPTACLE AND COVERPLATE AT POWER OUTLETS, FIELD VERIFY QUANTITY OF OUTLETS AND REQUIREMENTS.

) PROVIDE 2-3/4" X 1-11/32" TWO PIECE SURFACE METAL RACEWAY (WIREMOLD G3000 OR EQUAL) UNDER COUNTER WITH OUTLETS AS INDICATED. CIRCUIT OUTLETS TO SPARE IP-20A BREAKER IN ADJACENT PANEL THROUGH TELE/POWER POLE,

3 PROVIDE TWO COMPARTMENT (1-1/2" × 2-3/4" EACH) STEEL TELE/POWER POLE (WIREMOLD 30TP-4 OR EQUAL) BETWEEN ACCESSIBLE SPACE ABOVE CONTROL ROOM THROUGH COUNTER TO FLOOR UNDER COUNTER, PROVIDE ESCUTCHEON ON CEILING AND RIGIDLY SUPPORT POLE AT BOTH ENDS. CENTER POLE AT NEW WINDOW MULLION, COORDINATE LOCATION WITH OWNER'S REPRESENTATIVE,

4) PROVIDE BRANCH CIRCUIT TO NEW ELECTRIC TANKLESS WATER HEATER INCLUDING DISCONNECT AT HEATER, BRANCH CIRCUIT WIRING WITH RACEWAY AND BRANCH BREAKER IN ADJACENT PANEL, FIELD VERIFY AVAILABLE SPACE IN AND PANEL TYPE OF ADJACENT PANEL, INSTALL BRANCH CIRCUIT SURFACE MOUNTED TO ACCESSIBLE SPACE ABOVE CONTROL ROOM, FIELD VERIFY ROUTING REQUIREMENTS, COORDINATE WATER HEATER LOAD, VOLTAGE AND PHASE REQUIREMENTS WITH MECHANICAL CONTRACTOR.

CI) PROVIDE NEW CONTROL INTERLOCK BETWEEN CONTROL ROOM AND DOOR OPERATOR INCLUDING DOOR OPEN CONTROL RELAY, DOOR CLOSE CONTROL RELAY, DOOR CLOSED CONTACT AND DOOR OPEN CONTACT, COORDINATE REQUIREMENTS WITH EXISTING DOOR OPERATOR AND OWNER'S

C2) EXTEND RIGID GRC CONDUIT WITHOUT JUNCTION BOX OR CONDUIT BODIES FROM OPERATOR TO MINIMUM +12'-0" A.F.F.

C3) ROUTE CONDUIT SURFACE MOUNTED AT CEILING THROUGH MAIN CORRIDOR TO CONTROL ROOM, EXTEND CONTROL WIRING TO NEW DOOR CONTROL PANEL IN CONTROL ROOM THROUGH NEW TELE/POWER POLE, SEE DOOR CONTROL WIRING DIAGRAM SHEET EP601.

(C4) PROVIDE NEW DOOR CONTROL PANEL WITH DOOR OPEN-CLOSE SELECTOR SWITCHES, OPEN (RED) PILOT AND CLOSED (GREEN) PILOT LIGHTS, SEE DOOR CONTROL WIRING DIAGRAM AND DOOR CONTROL PANEL DETAIL SHEET EP601. PROVIDE NEW ADDITIONAL CONTROL CIRCUIT FROM ADJACENT PANEL 'E' SPARE IP-20A BRANCH BREAKER, FILED VERIFY REQUIREMENTS,

C5) INSTALL RELOCATED MECHANICAL SYSTEM CONTROL PANEL AS DIRECTED BY OWNER'S REPRESENTATIVE. PROVIDE I"C INTO ACCESSIBLE SPACE ABOVE CONTROL ROOM CEILING AND RECONNECT CONTROL WIRING, COORDINATE WITH OWNER'S CONTROL SYSTEM CONTRACTOR AND OWNER'S REPRESENTATIVE.

(C6) PROVIDE NEW CALL PUSHBUTTON IN CAST ALUMINUM ENCLOSURE: SQUARE D CLASS 9001 TYPE KY10/KRIBH13. EXTEND RIGID CONDUIT WITHOUT JUNCTION BOXES OR CONDUIT BODIES TO ACCESSIBLE CEILING SPACE ABOVE CONTROL ROOM. INTERLOCK PSUHBUTTON WITH NEW SIGNAL CHIME.

(C1) PROVIDE NEW SIGNAL CHIME AT CEILING OF CONTROL ROOM; EDWARDS TYPE 338-N5, PROVIDE NEW FLUGH OUTLET BOX AS REQUIRED TO INSTALL DEVICE, COORDINATE LOCATION WITH OWNER'S REPRESENTATIVE, PROVIDE NEW CONTROL CIRCUIT FROM ADJACENT PANEL INCLUDING NEW IP-2004 BRANCH

(FAI) RELOCATE FIRE ALARM CONTROL PANEL - SIMPLEX GRINNELL TYPE '4100' ADDRESSABLE PANEL, PROVIDE NEW EQUIPMENT ENCLOSURE AND EXTEND NEW CONDUITS TO GUTTER ABOVE CONTROL ROOM, RELOCATE PANEL EQUIPMENT, INITIATING DEVICE CIRCUIT(6), SIGNALING LINE CIRCUIT(6), NOTIFICATION APPLIANCE CIRCUIT(S) AND EQUIPMENT SHUTDOWN INTERLOCKS TO NEW PANEL ENCLOSURE, COORDINATE REQUIREMENTS WITH EXISTING CONDITIONS AND OWNER'S REPRESENTATIVE.

(FA2) INTERCEPT EXISTING INITIATING DEVICE CIRCUIT(5), SIGNALING LINE CIRCUIT(5), NOTIFICATION APPLIANCE CIRCUIT(S) AND EQUIPMENT SHUTDOWN INTERLOCKS, PROVIDE GUTTER IN ACCESSIBLE SPACE ABOVE CONTROL ROOM CEILING, EXTEND LOOPS TO NEW CONTROL PANEL LOCATION, (REFERENCE INFORMATION: SEVEN (1) EXISTING 34"C FROM ABOVE CEILING TO EXISTING CONTROL PANEL, EXISTING FIRE ALARM SYSTEM HAS BEEN CONVERTED FROM WIRED ZONED SYSTEM TO ADDRESSABLE SYSTEM, FIVE (5) INITIATING DEVICE CIRCUIT ZONES COMBINED AT PANEL TO FORM ONE (1) ADDRESSABLE LOOP WITH SIGNALING LINE CIRCUIT FOR DENTAL OFFICES.)

FA3) PROVIDE NEW ANNUNCIATOR IN FACE OF DOOR CONTROL PANEL (APPROX 4-1/2" × 11-13/16"), SEE DOOR CONTROL PANEL DETAIL SHEET EP601: SIMPLEX TYPE 4603-1901, COORDINATE ANNUNCIATOR REQUIREMENTS WITH SIMPLEX REPRESENTATIVE. PROVIDE NEW CONTROL CABLE BETWEEN RELOCATED FIRE ALARM CONTROL PANEL AND ANNUNICIATOR.

TI) EXISTING TELEPHONE/DATA ENCLOSURE TO REMAIN AS PULLBOX, PROVIDE NEW COVERPLATE FOR ENCLOGURE (COORDINATE LOCATION IN MILLWORK WITH GENERAL CONTRACTOR AS REQUIRED TO ALLOW ACCESS THROUGH CABINET). PROVIDE 2-3/4" X 1-11/32" TWO PIECE SURFACE METAL RACEWAY (WIREMOLD G3000 OR EQUAL) FROM ENCLOSURE TO TELE/POWER POLE, NEW CABLES BY OWNER, COORDINATE RACEWAY REQUIREMENTS WITH OWNER'S REPRESENTATIVE

T2) PROVIDE 2"C FROM COMMUNICATIONS CLOSET TO TELE/POWER POLE THROUGH ACCESSIBLE SPACE ABOVE CONTROL ROOM.

(DI) REMOVE/RELOCATE EXISTING FIRE ALARM CONTROL PANEL, SEE CONTROL ROOM EQUIPMENT PLAN THIS SHEET,

(D2) REMOVE ABANDONED DOOR CONTROL PANEL COMPLETE.

D3) REMOVE EXISTING DOOR CONTROL PANEL. RETAIN EXISTING DOOR CONTROL CONNECTIONS FOR NEW DOOR CONTROL PANEL, FIELD VERIFY EXISTING CONTROL WIRING PRIOR TO BEGINNING WORK AND COORDINATE WITH NEW CONTROL PANEL REQUIREMENTS, DOOR CONTROLS SHALL REMAIN IN OPERATION AT ALL TIMES (CONTROLS MAY BE OUT OF OPERATION DURING DAY SHIFT BUT SHALL BE RETURNED TO WORKING ORDER BEFORE END OF THAT SHIFT, COORDINATE WITH OWNER'S REPRESENTATIVE).

D4) REMOVE EXISTING TELEPHONE/DATA CROSS-CONNECTS AND TERMINATIONS. LEAVE ONE (1) ENCLOSURE AS PULLBOX, COORDINATE ACCESS THROUGH NEW CABINET WITH GENERAL CONTRACTOR.

(D5) RELOCATE EXISTING MECHANICAL SYSTEM CONTROL PANEL.

ARCHITECT #0568



ajc architects

703 east 1700 south salt lake city, utah 84105 ph: 801.466.8818 fx: 801.466.4411 ajc@ajcarchitects.com

Thomas and Kolkman Engineering 64 West 1700 South Salt Lake City, Utah 84115 PH#: (801) 484-8161 FAX: (801) 484-3538



OWNER INFORMATION

### State of Utah Department of Administrative Services



4110 State Office Building Salt Lake City, Utah 84114 Phone: (801) 538 - 3018 Fax: (801) 538 - 3267

Internet: http://www.dfcm.utah.gov

PROJECT DESCRIPTION

# **UTAH STATE** PRISON CONTROL ROOM

DRAPER, UTAH

SHEET NAME:

B UINTA **EQUIPMENT PLANS** DEMOLITION PLAN

REVISIONS

DATE DESCRIPTION


ISSUE DATA

ISSUE DATE: FEBRUARY 2006 ISSUE TYPE: CON. DOCS. DRAWN BY: R.G. KOLKMAN CHECKED BY: W.B. GRANDY CAD FILE NAME: 0568.EP101.DWG

DFCM PROJECT # 05032100 COPYRIGHT: STATE OF UTAH

SHEET NUMBER:



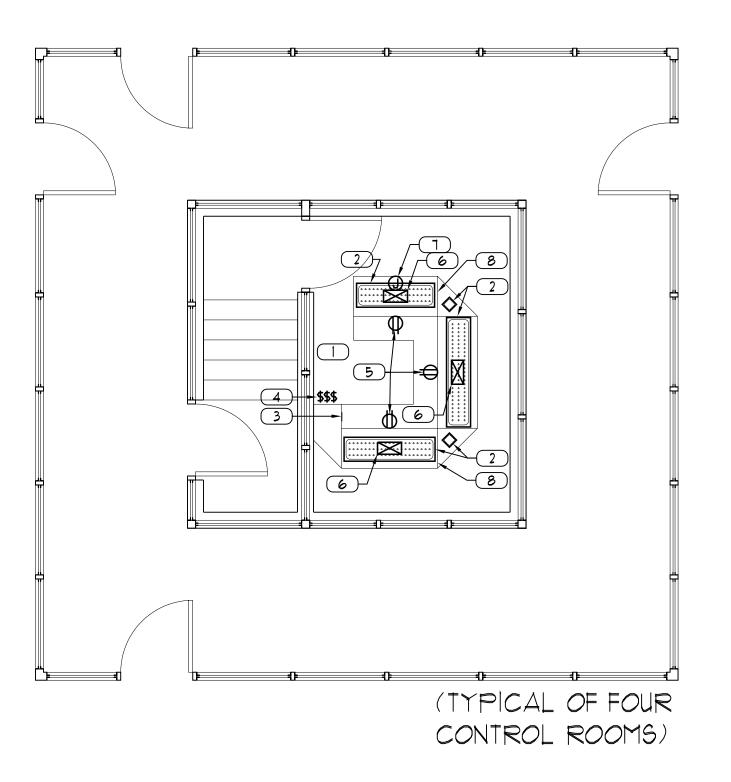

GENERAL NOTES:

WHERE BRANCH CIRCUIT HOMERUNS INDICATE WIRE SIZES, THE BRANCH CIRCUIT SHALL BE THAT SIZE WIRE THROUGHOUT, INCLUDING SWITCH LEGS, ETC.

• COORDINATE EXISTING CEILING, WALLS AND FLOOR REPAIRS WITH THE GENERAL CONTRACTOR.

DEMOLITION

 LOCATIONS OF EXISTING ELECTRICAL EQUIPMENT, SWITCHES, OUTLETS, BRANCH CIRCUIT WIRING, ETC., ARE BASED ON EXISTING BUILDING ELECTRICAL DRAWINGS AND FIELD OBSERVATION OF EXISTING SURFACE CONDITIONS. FIELD VERIFY EXISTING LOCATIONS AND CIRCUITING AND IMMEDIATELY NOTIFY THE ARCHITECT OF ANY DISCREPANCIES WHICH MAY ADVERSELY AFFECT COMPLETION OF THE WORK.

- DEMOLÍTION PLAN IS SHOWN FOR CONTRACTORS REFERENCE ONLY, FIELD VERIFY QUANTITIES AND LOCATIONS OF ALL EXISTING MATERIAL AND EQUIPMENT TO BE REMOVED, REMOVE ALL ABANDONED CONDUIT WIRING, JUNCTION BOXES, OUTLETS, LIGHT FIXTURES, EQUIPMENT, ETC, WHETHER SPECIFICALLY SHOWN OR NOT.
- ONTRACTOR MAY USE EXISTING BRANCH CIRCUIT WIRING AND RACEWAYS WHERE CONVENIENT TO CONNECT TO NEW ELECTRICAL DEVICES ONLY IF THE EXISTING WIRING AND RACEWAYS ARE IN GOOD CONDITION AND MEET DIVISION IS SPECIFICATION REQUIREMENTS FOR NEW WIRING AND RACEWAYS.
- WHERE REMOVAL OF EXISTING ELECTRICAL EQUIPMENT INTERRUPTS EXISTING BRANCH CIRCUITS OR FEEDERS TO EXISTING EQUIPMENT TO REMAIN, FURNISH AND INSTALL NEW CONDUIT AND WIRING AS REQUIRED TO RECONNECT THE EXISTING EQUIPMENT TO REMAIN.
- ALL MATERIALS AND EQUIPMENT REMOVED SHALL REMAIN THE PROPERTY OF THE OWNER AND SHALL BE TURNED OVER TO THE OWNER FOR STORAGE OR BE DISPOSED OF BY THE CONTRACTOR AS DIRECTED BY THE OWNER.
- TAKE ALL PRECAUTIONS NECESSARY TO AVOID DAMAGE TO THE EXISTING BUILDING. REPAIR ALL DAMAGE INCURRED BY DEMOLITION AND NEW CONSTRUCTION TO EXACTLY MATCH EXISTING SURFACES AND/OR CONDITIONS WITHOUT ADDITIONAL COST TO THE OWNER. COORDINATE REPAIRS WITH THE GENERAL CONTRACTOR.

### **KEYED NOTE LEGEND:**

- CONTROL PANELS, EQUIPMENT, CONNECTIONS, ANNUNCIATORS, SWITCHES, ETC., SHOWN ARE FOR REFERENCE. RELOCATE ALL EXISTING EQUIPMENT INCLUDING ALL CONTROL PANELS, EQUIPMENT, CONNECTIONS, ANNUNCIATORS, SWITCHES, ETC. WHETHER SHOWN OR NOT. NEW CABINET SHALL BE MODULAR TO ALLOW INSTALLATION OF INDIVIDUAL SECTIONS AS NECESSARY TO MINIMIZE CONTROL ROOM DISRUPTIONS. GATE CONTROLS SHALL REMAIN IN OPERATION AT ALL TIMES (CONTROLS MAY BE OUT OF OPERATION DURING DAY SHIFT BUT SHALL BE RETURNED TO WORKING ORDER BEFORE END OF THAT SHIFT, COORDINATE WITH FACILITY PERSONNEL). FIELD VERIFY EXISTING CONDITIONS PRIOR TO BEGINNING WORK.
- 2 RELOCATE EXISTING CONTROL PANEL(S) FROM EXISTING CABINET TO NEW CABINET. COORDINATE REQUIRED OPENINGS AND CONSTRUCTION OF NEW MILLWORK WITH GENERAL CONTRACTOR AS NECESSARY TO ACCOMMODATE EXISTING CONTROL PANELS. EXISTING GATE CONTROL PANELS ARE CONNECTED BY FOUR (4) CORD AND PLUG CONNECTORS PER PANEL. EXISTING ANNUNCIATORS, SWITCHES, MONITORS, OUTLETS ARE HARDWIRED WITH FLEXIBLE METAL CONDUIT RACEWAYS. DISCONNECT AND RECONNECT EQUIPMENT AS REQUIRED.
- 3 RELOCATE FIRE ALARM ANNUNCIATOR FROM EXISTING CABINET TO CABINET.
  COORDINATE REQUIRED OPENINGS AND CONSTRUCTION OF NEW MILLWORK WITH
  GENERAL CONTRACTOR AS NECESSARY TO ACCOMMODATE EXISTING
  ANNUNCIATOR EXISTING ANNUNCIATOR HARDWIRED WITH FLEXIBLE METAL
  CONDUIT RACEWAYS, DISCONNECT AND RECONNECT EQUIPMENT AS REQUIRED.
- 4 RELOCATE EVAPORATIVE COOLER CONTROL SWITCHES FROM EXISTING CABINET TO CABINET, COORDINATE REQUIRED OPENINGS AND CONSTRUCTION OF NEW MILLWORK WITH GENERAL CONTRACTOR AS NECESSARY TO ACCOMMODATE EXISTING SWITCHES, EXISTING SWITCHES HARDWIRED WITH FLEXIBLE METAL CONDUIT RACEWAYS, DISCONNECT AND RECONNECT EQUIPMENT AS REQUIRED.
- PROVIDE NEW OUTLETS IN TOE-KICK OF CABINET, CONNECT OUTLETS TO EXISTING POWER CIRCUIT, COORDINATE REQUIREMENTS OF NEW MILLWORK WITH GENERAL CONTRACTOR AS NECESSARY TO ACCOMMODATE OUTLETS, FIELD VERIFY CIRCUIT AND RACEWAY REQUIREMENTS,
- 6 EXISTING POWER, DATA AND CONTROL CONDUITS STUB INTO EXISTING CABINET FROM BELOW. COORDINATE REQUIRED OPENINGS AND CONSTRUCTION OF NEW MILLWORK WITH GENERAL CONTRACTOR AS NECESSARY TO ACCOMMODATE EXISTING RACEWAYS. FIELD VERIFY EXISTING RACEWAY LOCATIONS.
- 1 EXISTING HARD PIPED JUNCTION BOX TO REMAIN, MOUNTED TO SIDE OF EXISTING CABINET. COORDINATE CONSTRUCTION OF NEW MILLWORK WITH GENERAL CONTRACTOR AS NECESSARY TO ACCOMMODATE REMOUNT JUNCTION IN NEW CABINET. FIELD VERIFY REQUIREMENTS.
- 8 NEW CABINET TO BE MODULAR, COORDINATE REQUIRED OPENINGS AND CONSTRUCTION OF NEW MILLWORK WITH GENERAL CONTRACTOR AS NECESSARY TO ACCOMMODATE EXISTING RACEWAYS AND CABLES. INCLUDE COST TO DISCONNECT EACH CONTROL PANEL, ANNUNCIATOR AND EQUIPMENT INCLUDING SIX (6) HARDWIRED FLEXIBLE METAL CONDUIT CONNECTIONS PER SECTION A MINIMUM OF THREE (3) TIMES (ONCE FOR THREE (3) SECTIONS OF CABINET), FIELD VERIFY REQUIREMENTS.
- DI REMOVE EXISTING DIMMING PANEL COMPLETE AND CONTROLS, FIELD VERIFY EXISTING CONTROL WIRING PRIOR TO BEGINNING WORK AND COORDINATE WITH REQUIREMENTS WITH FACILITY PERSONNEL.

ARCHITECT




ajc architects

#0568

703 east 1700 south salt lake city, utah 84105 ph: 801.466.8818 fx: 801.466.4411 ajc@ajcarchitects.com

ELECTRICAL
Thomas and Kolkman Engineering
64 West 1700 South
Salt Lake City, Utah 84115
PH#: (801) 484-8161 FAX: (801) 484-3538

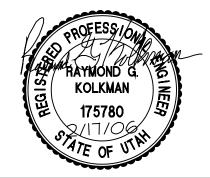

OWNER INFORMATION

# State of Utah Department of Administrative Services



Division of Facilities Construction & Management 4110 State Office Building Salt Lake City, Utah 84114 Phone: (801) 538 - 3018 Fax: (801) 538 - 3267

Internet: http://www.dfcm.utah.gov

PROJECT DESCRIPTION

# UTAH STATE PRISON CONTROL ROOM REMODEL

DRAPER, UTAH

T ....

SHEET NAME:

OQUIRRH

EQUIPMENT PLAN

DEMOLITION PLAN

REVISIONS

MARK DATE DESCRIPTION

ISSUE DATA


ISSUE DATE: FEBRUARY 2006
ISSUE TYPE: CON. DOCS.
DRAWN BY: R.G. KOLKMAN
CHECKED BY: W.B. GRANDY
CAD FILE NAME: 0568.EP102.DWG


DFCM PROJECT # 05032100 COPYRIGHT: STATE OF UTAH


SHEET NUMBER:

EP102

5

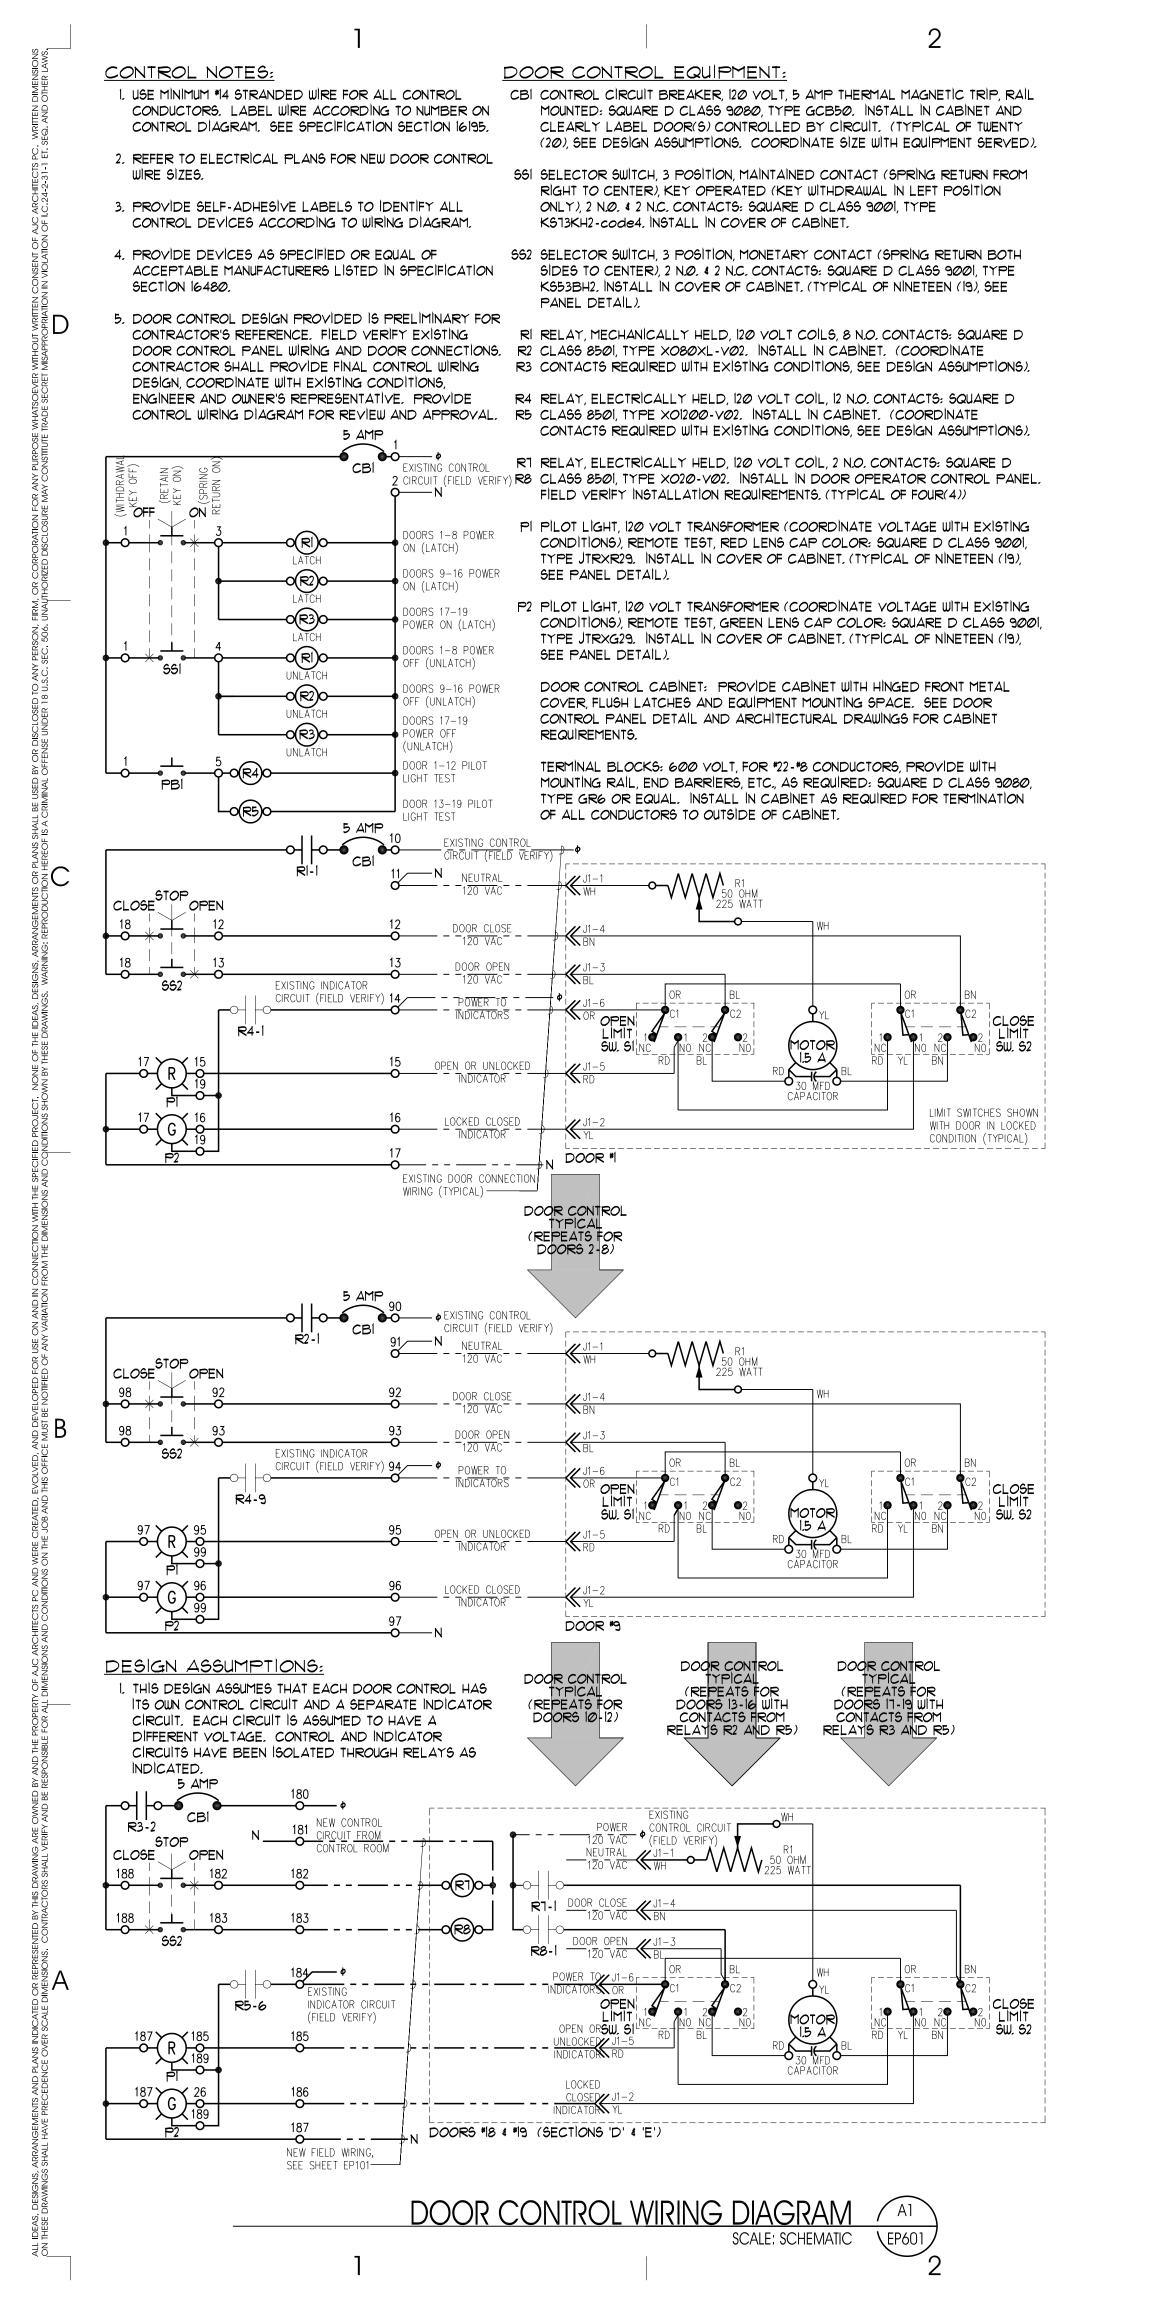

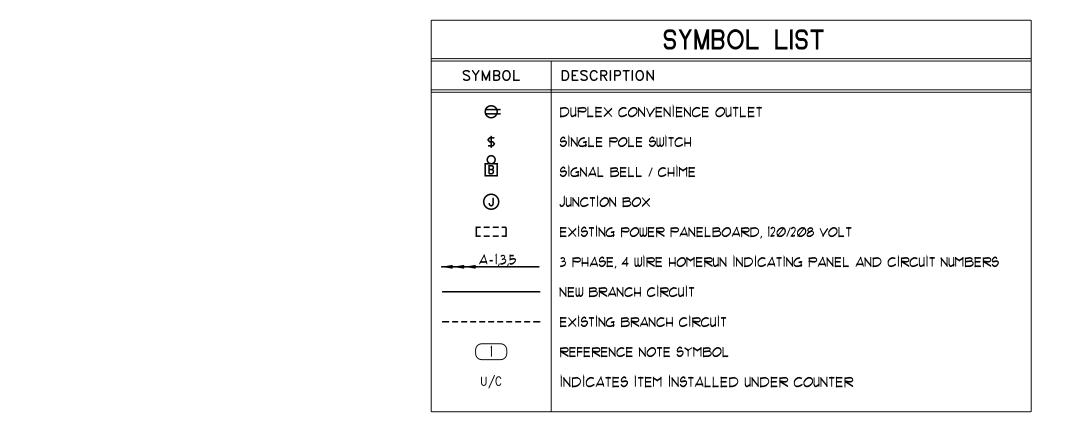

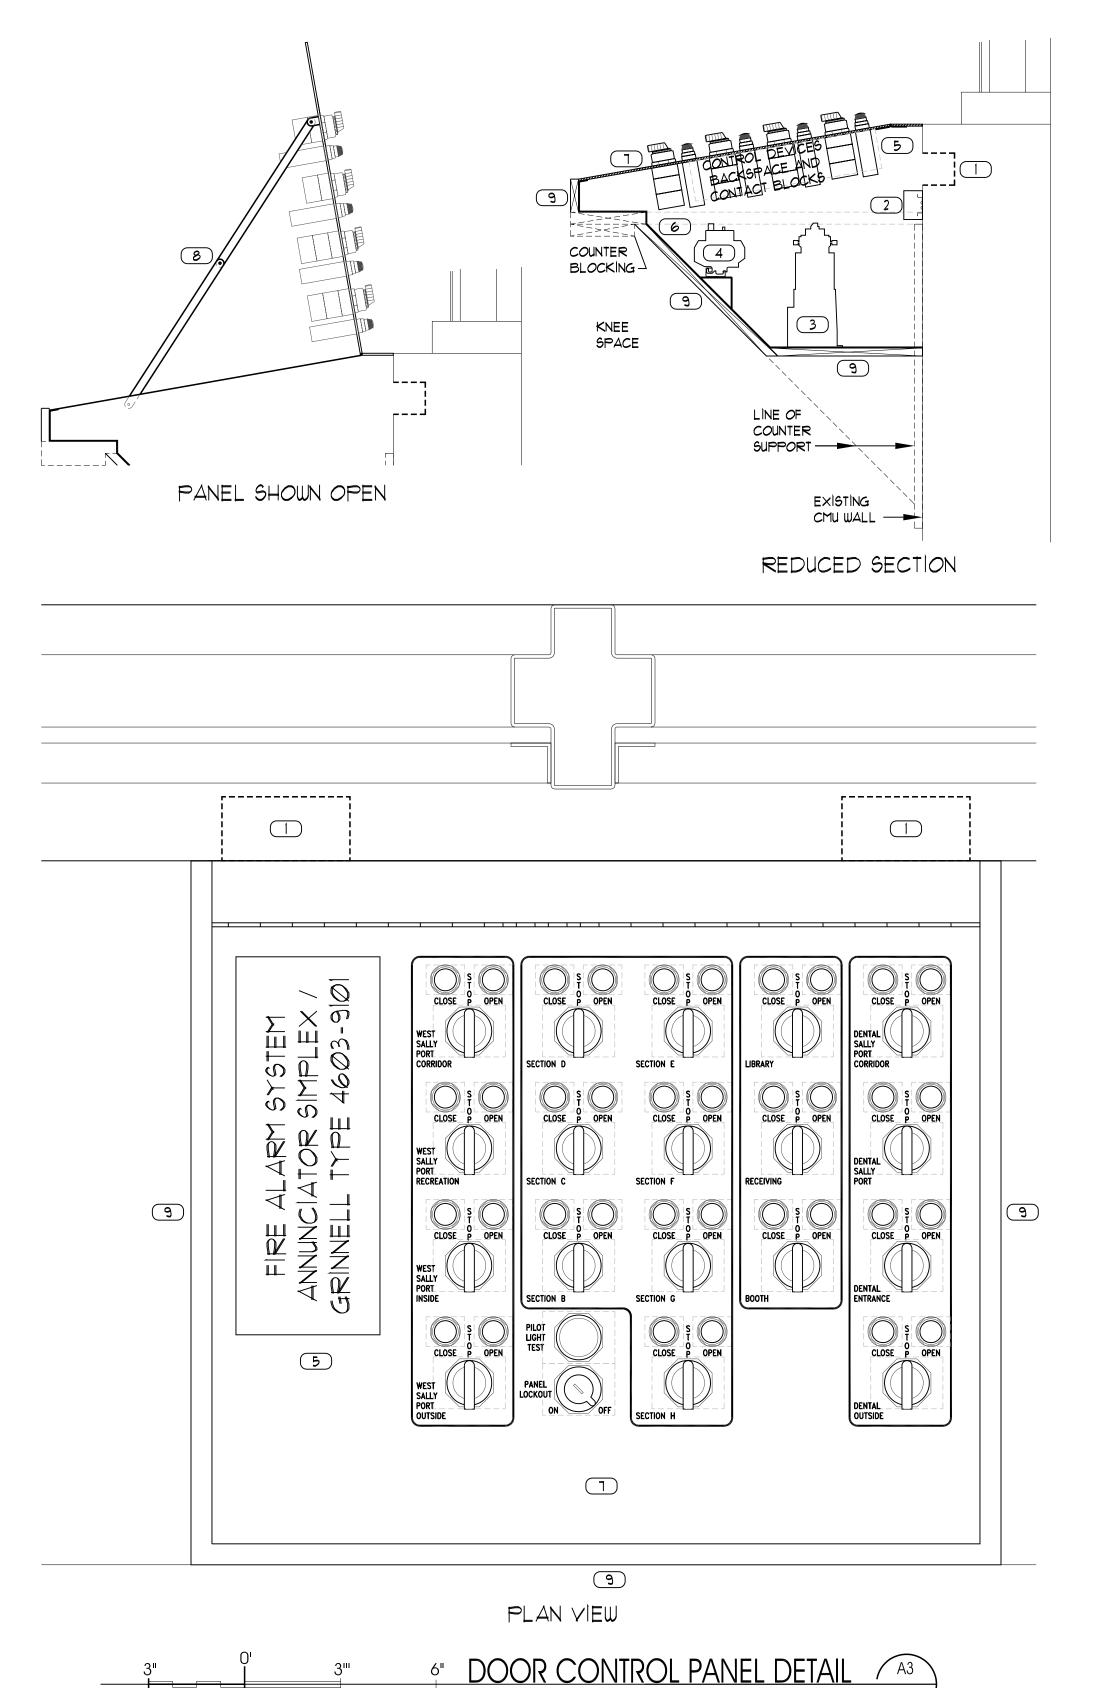

scale = 1" = 3"

## **GENERAL NOTES:**

- LOCATIONS OF EXISTING ELECTRICAL EQUIPMENT, SWITCHES, OUTLETS, BRANCH CIRCUIT WIRING, ETC., ARE BASED ON LIMITED EXISTING BUILDING ELECTRICAL DRAWINGS AND FIELD OBSERVATION OF EXISTING SURFACE CONDITIONS, FIELD VERIFY EXISTING LOCATIONS AND CIRCUITING AND IMMEDIATELY NOTIFY THE ARCHITECT OF ANY DISCREPANCIES WHICH MAY ADVERSELY AFFECT COMPLETION OF THE WORK,
- DOOR CONTROL DESIGN AND PANEL LAYOUT PROVIDED ARE PRELIMINARY FOR CONTRACTOR'S REFERENCE, FIELD VERIFY EXISTING DOOR CONTROL PANEL WIRING AND DOOR CONNECTIONS, CONTRACTOR SHALL PROVIDE FINAL CONTROL WIRING DESIGN AND PANEL LAYOUT, COORDINATE WITH EXISTING CONDITIONS, GENERAL CONTRACTOR, ENGINEER AND OWNER'S REPRESENTATIVES, PROVIDE CONTROL WIRING DIAGRAM AND COMPLETE PANEL LAYOUT INCLUDING CONSTRUCTION DETAILS FOR REVIEW AND APPROVAL,
- WIRING IN CONTROL PANEL SHALL BE GROUPED AND BUNDLED TOGETHER AND ROUTED SUCH THAT ALL DEVICES AND TERMINALS ARE ACCESSIBLE. CONDUCTORS AND CABLES SHALL HAVE SUFFICIENT LENGTH SUCH THAT THE CONTROL PANEL COVER OPENS FREELY AND COMPLETELY, OPENING OF CONTROL PANEL COVER SHALL NOT REQUIRE CONDUCTORS OR CABLES TO BE DISCONNECTED.
- EXISTING DOOR CONTROL PANEL SHALL BE REMOVED. RETAIN EXISTING DOOR CONTROL CONNECTIONS FOR NEW DOOR CONTROL PANEL, FIELD VERIFY EXISTING CONTROL WIRING PRIOR TO BEGINNING WORK AND COORDINATE WITH NEW CONTROL PANEL REQUIREMENTS. DOOR CONTROLS SHALL REMAIN IN OPERATION AT ALL TIMES (CONTROLS MAY BE OUT OF OPERATION DURING DAY SHIFT BUT SHALL BE RETURNED TO WORKING ORDER BEFORE END OF THAT SHIFT, COORDINATE WITH OWNER'S REPRESENTATIVE. CONTRACTOR SHALL WORK IN PHASES AS NECESSARY TO ACCOMMODATE OPERATIONAL REQUIREMENTS).
- PROVIDE SAMPLE OF ONE DOOR STATION ASSEMBLED WITH SELECTOR SWITCH (662), PILOT LÌGHT6 (PI&P2), PAINT WITH GRAPHICS AND FLUSH LATCH FOR OWNER'S REVIEW AND APPROVAL PRIOR TO BEGINNING WORK.




ARCHITECT

ajc architects

#0568

703 east 1700 south salt lake city, utah 84105 ph: 801.466.8818 fx: 801.466.4411 ajc@ajcarchitects.com

Thomas and Kolkman Engineering 64 West 1700 South Salt Lake City, Utah 84115 PH#: (801) 484-8161 FAX: (801) 484-3538

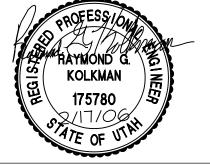

OWNER INFORMATION

#### State of Utah Department of Administrative Services

Division of Facilities Construction & Management 4110 State Office Building Salt Lake City, Utah 84114 Phone: (801) 538 - 3018 Fax: (801) 538 - 3267

Internet: http://www.dfcm.utah.gov

PROJECT DESCRIPTION

# UTAH STATE PRISON CONTROL ROOM

DRAPER, UTAH

SHEET NAME: **UINTA GATE CONTROL** PANEL DETAIL

8 PROVIDE CONTROL PANEL WITH HOLD-OPEN STRUTS ON BOOTH SIDES.

HANDLES, PAINT COVER AND PROVIDE LETTERING LABELING DEVICES, SEE

EXISTING RECESSED OUTLET BOX WITH DOOR CONTROL CONNECTIONS. FIELD

VERIFY LOCATIONS AND ADJACENT CONTROL PANEL LOCATION AND

3 INSTALL RELAYS IN CONTROL PANEL WITH REQUIRED CLEARANCES AND

(4) INSTALL CONTROL CIRCUIT BREAKERS IN EASILY ACCESSIBLE LOCATION AT

FRONT OF CONTROL PANEL, LABEL BREAKER WITH DOOR CONTROLLED. PROVIDE MOUNTING BRACKET TO SQUARE BREAKERS TO FRONT ACCESS.

5 INSTALL NEW FIRE ALARM ANNUNCIATOR IN FRONT COVER OFF CONTROL PANEL.

6 ) CONTROL PANEL ENCLOSURE SHALL BE METAL ON ALL SIDES WITH ACCESS OPENINGS FOR EXISTING DOOR CONNECTIONS, CONTROL PANEL SHOWN

FOLLOWING CONTOURS OF COUNTER SUPPORTS BELOW TOP OF COUNTER.

ARCHITECTURAL PLANS FOR PAINTING AND LETTERING REQUIREMENTS.

COORDINATE LABELING OF DEVICES WITH OWNER'S REPRESENTATIVE.

1 ) HINGED FRONT METAL COVER WITH HAND OPERATED FLUSH LATCHES /

NEW CONTROL CONNECTIONS ON TERMINAL STRIP(S).

2) PROVIDE TERMINAL STRIP(S) IN CONTROL PANEL, TERMINATE EXISTING AND

ARCHITECTURAL FACING AND BLOCKING TO MATCH CABINETS AND COUNTERS, SEE ARCHITECTURAL DETAILS AND PLANS.

**KEYED NOTE LEGEND:** 

DIMENSIONS AS REQUIRED.

ACCESS,

WIRING DIAGRAM

REVISIONS

DATE DESCRIPTION

ISSUE DATA

ISSUE DATE: FEBRUARY 2006 ISSUE TYPE: CON. DOCS. DRAWN BY: R.G. KOLKMAN CHECKED BY: W.B. GRANDY CAD FILE NAME: 0568.EP101.DWG

DFCM PROJECT # 05032100 STATE OF UTAH COPYRIGHT:

| SHEET NUMBER: